# Landscape Documentation Development Application 26 Elizabeth Street, Liverpool NSW 2170

### Drawing Schedule

Drawing Number	Drawing Title	Scale
L-000	Landscape Coversheet	N/A
L-100	Landscape Composite Render	1:150
L-101	Landscape Plan - Ground Floor	1:150
L-102	Landscape Plan - Level 2	1:150
L-103	Landscape Plan - Level 3	1:150
L-104	Landscape Plan - Level 4	1:150
L-105	Landscape Plan - Level 5	1:150
L-106	Landscape Plan - Level 9	1:150
L-500	Landscape Specification Notes	N/A
L-501	Landscape Details	Varies
L-502	Landscape Green Wall Details	Varies

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> A For DA Approval Issue Revision Description

NP RS 18.03.2020 Drawn Check Date

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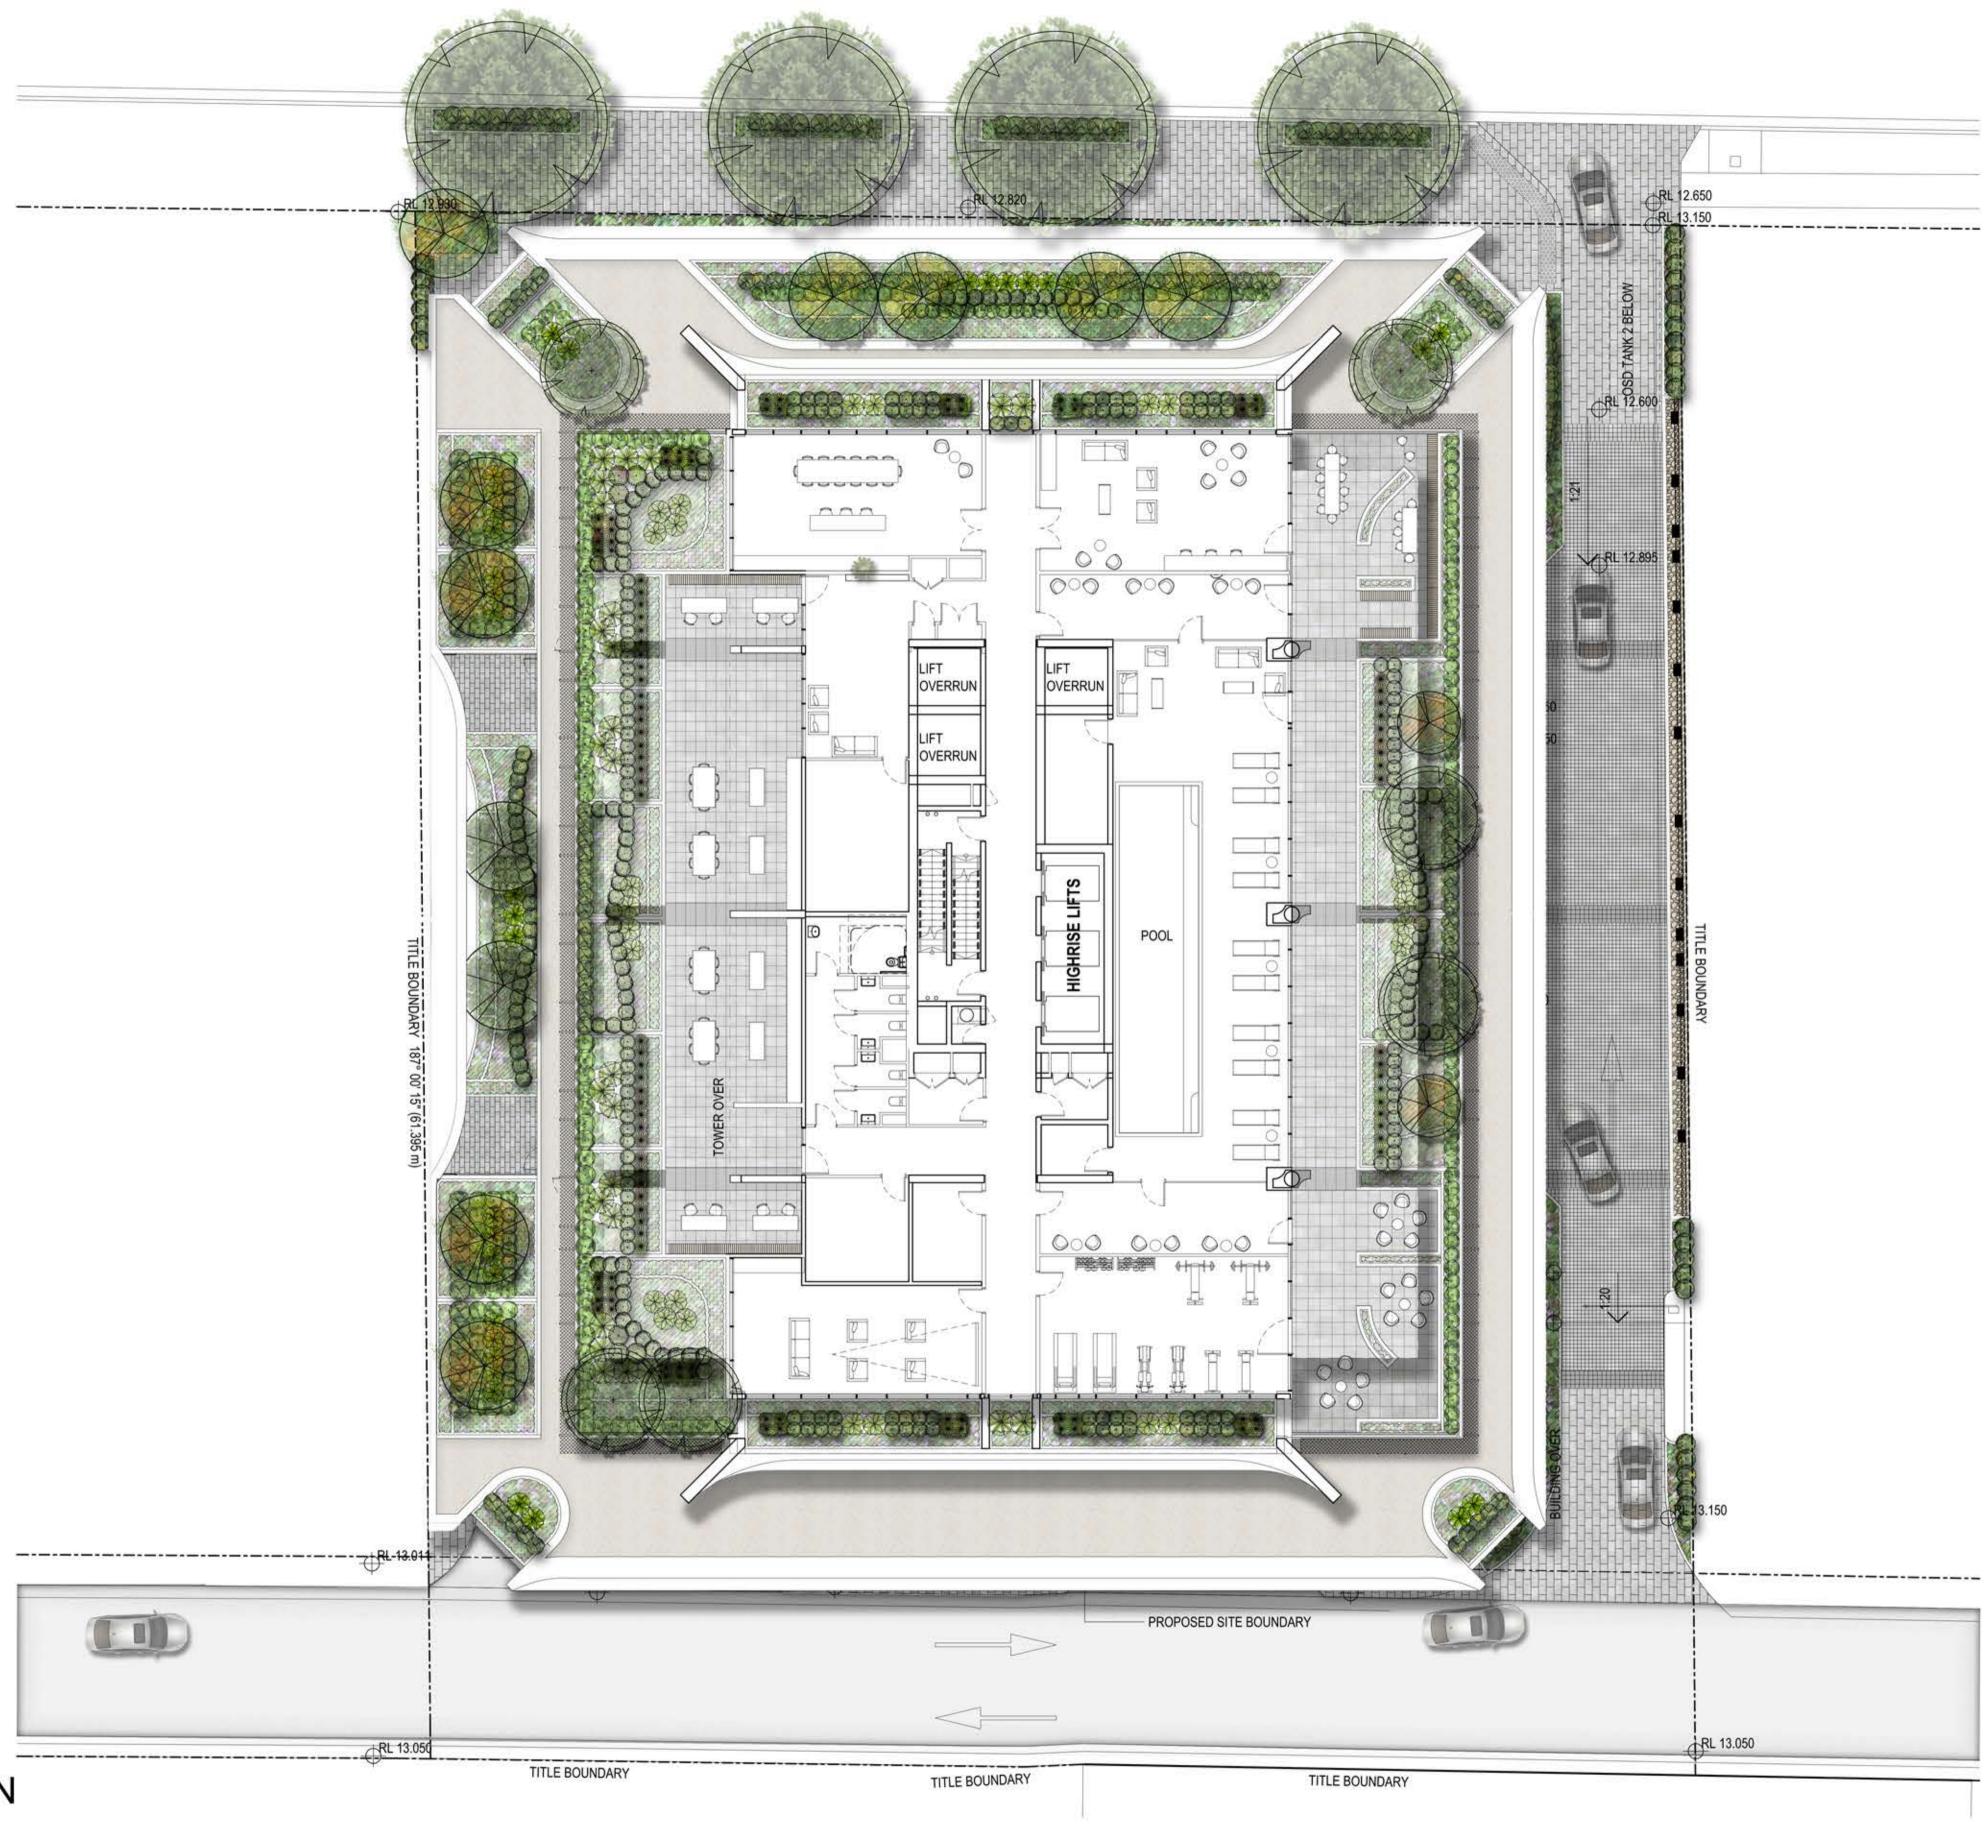
Rothelowman Architects

26 Elizabeth Street Liverpool NSW 2170 Drawing Name: Coversheet

DEVELOPMENT APPLICATION

Job Number: Drawing Number SS20-4354 L-000 A

#### **ELIZABETH** STREET



Key Plan:

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Issue Revision Description

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LEGEND Concrete Bench Seat Proposed Accent & Shrubs
(Refer Planting Schedule) Proposed Groundcover / Grass Render & Painted Blockwork Wall 600 x 300 Unit Paver 150 x 150 Unit Paver 100 x 100 Unit Paver NP RS 17.03.2020 Drawn Check Date

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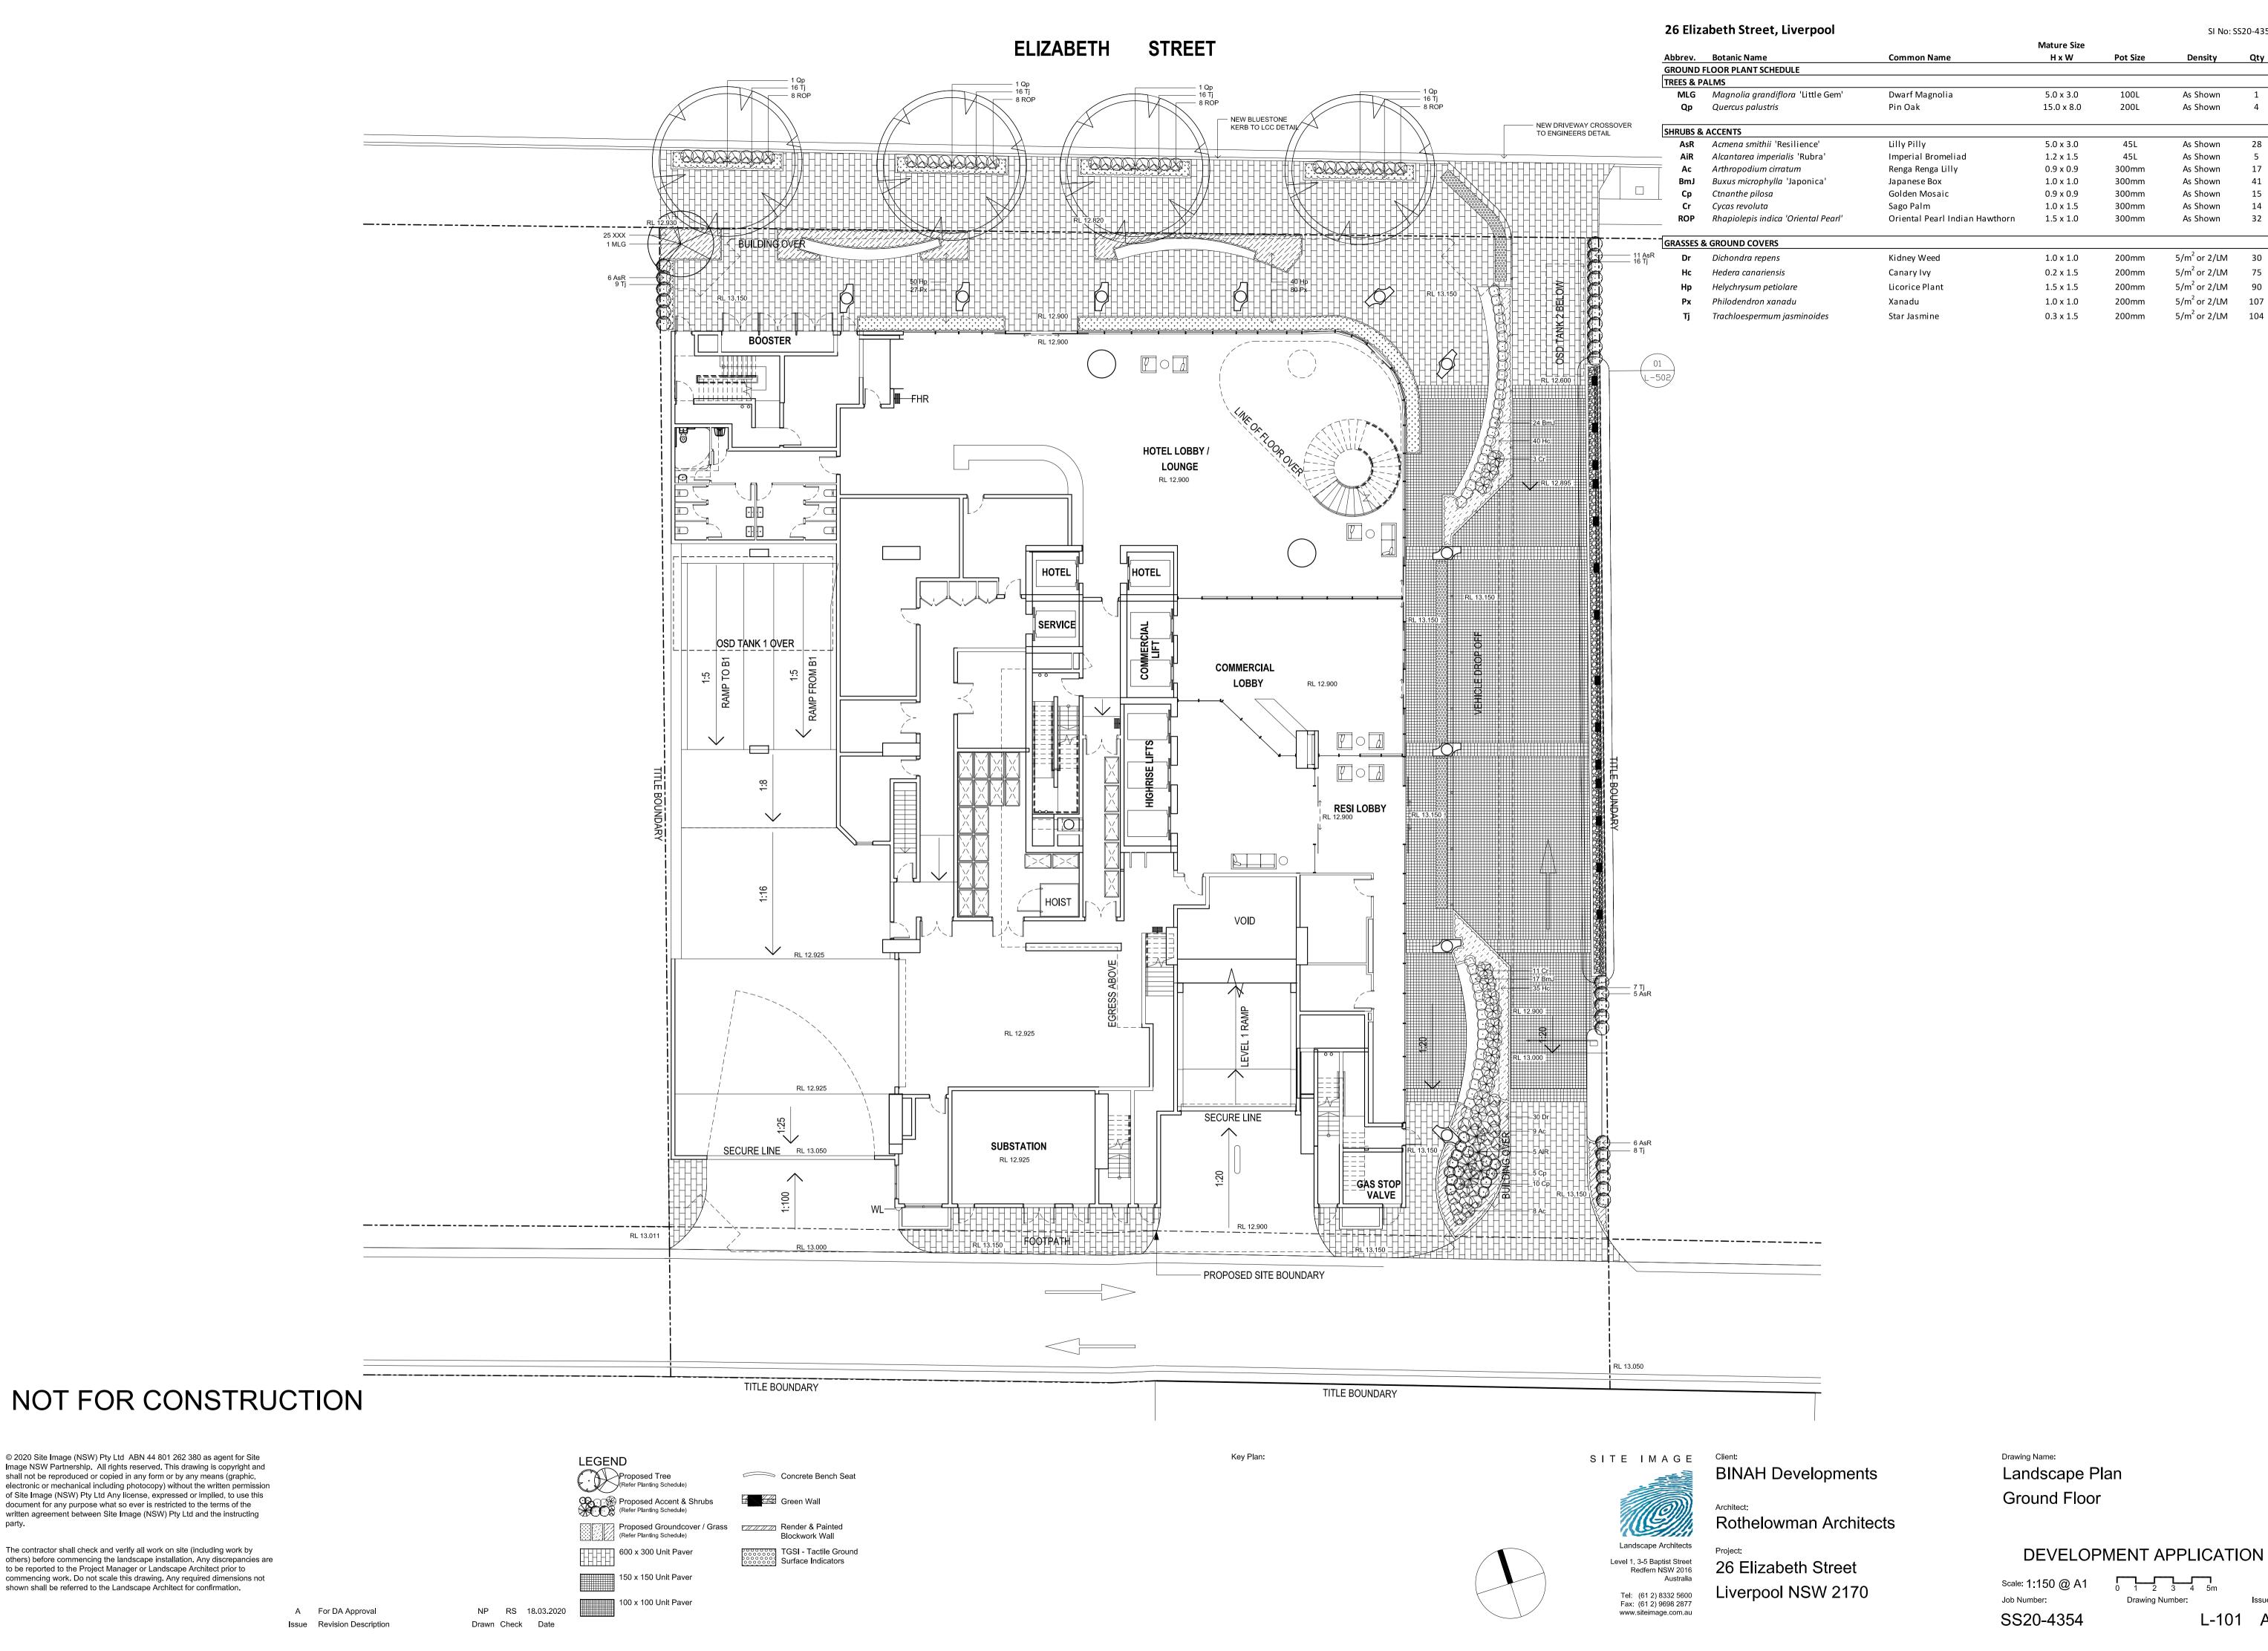
**BINAH Developments** Rothelowman Architects 26 Elizabeth Street

Composite Landscape Plan

DEVELOPMENT APPLICATION

Scale: 1:150 @ A1 0 1 2 3 4 5m

Job Number: Drawing Number: SS20-4354 L-C100 A



SI No: SS20-4354

As Shown

As Shown

As Shown

As Shown

As Shown

As Shown

5/m² or 2/LM

5/m² or 2/LM

5/m<sup>2</sup> or 2/LM 90


5/m<sup>2</sup> or 2/LM 107

5/m<sup>2</sup> or 2/LM 104

L-101 A

45L

shown shall be referred to the Landscape Architect for confirmation.

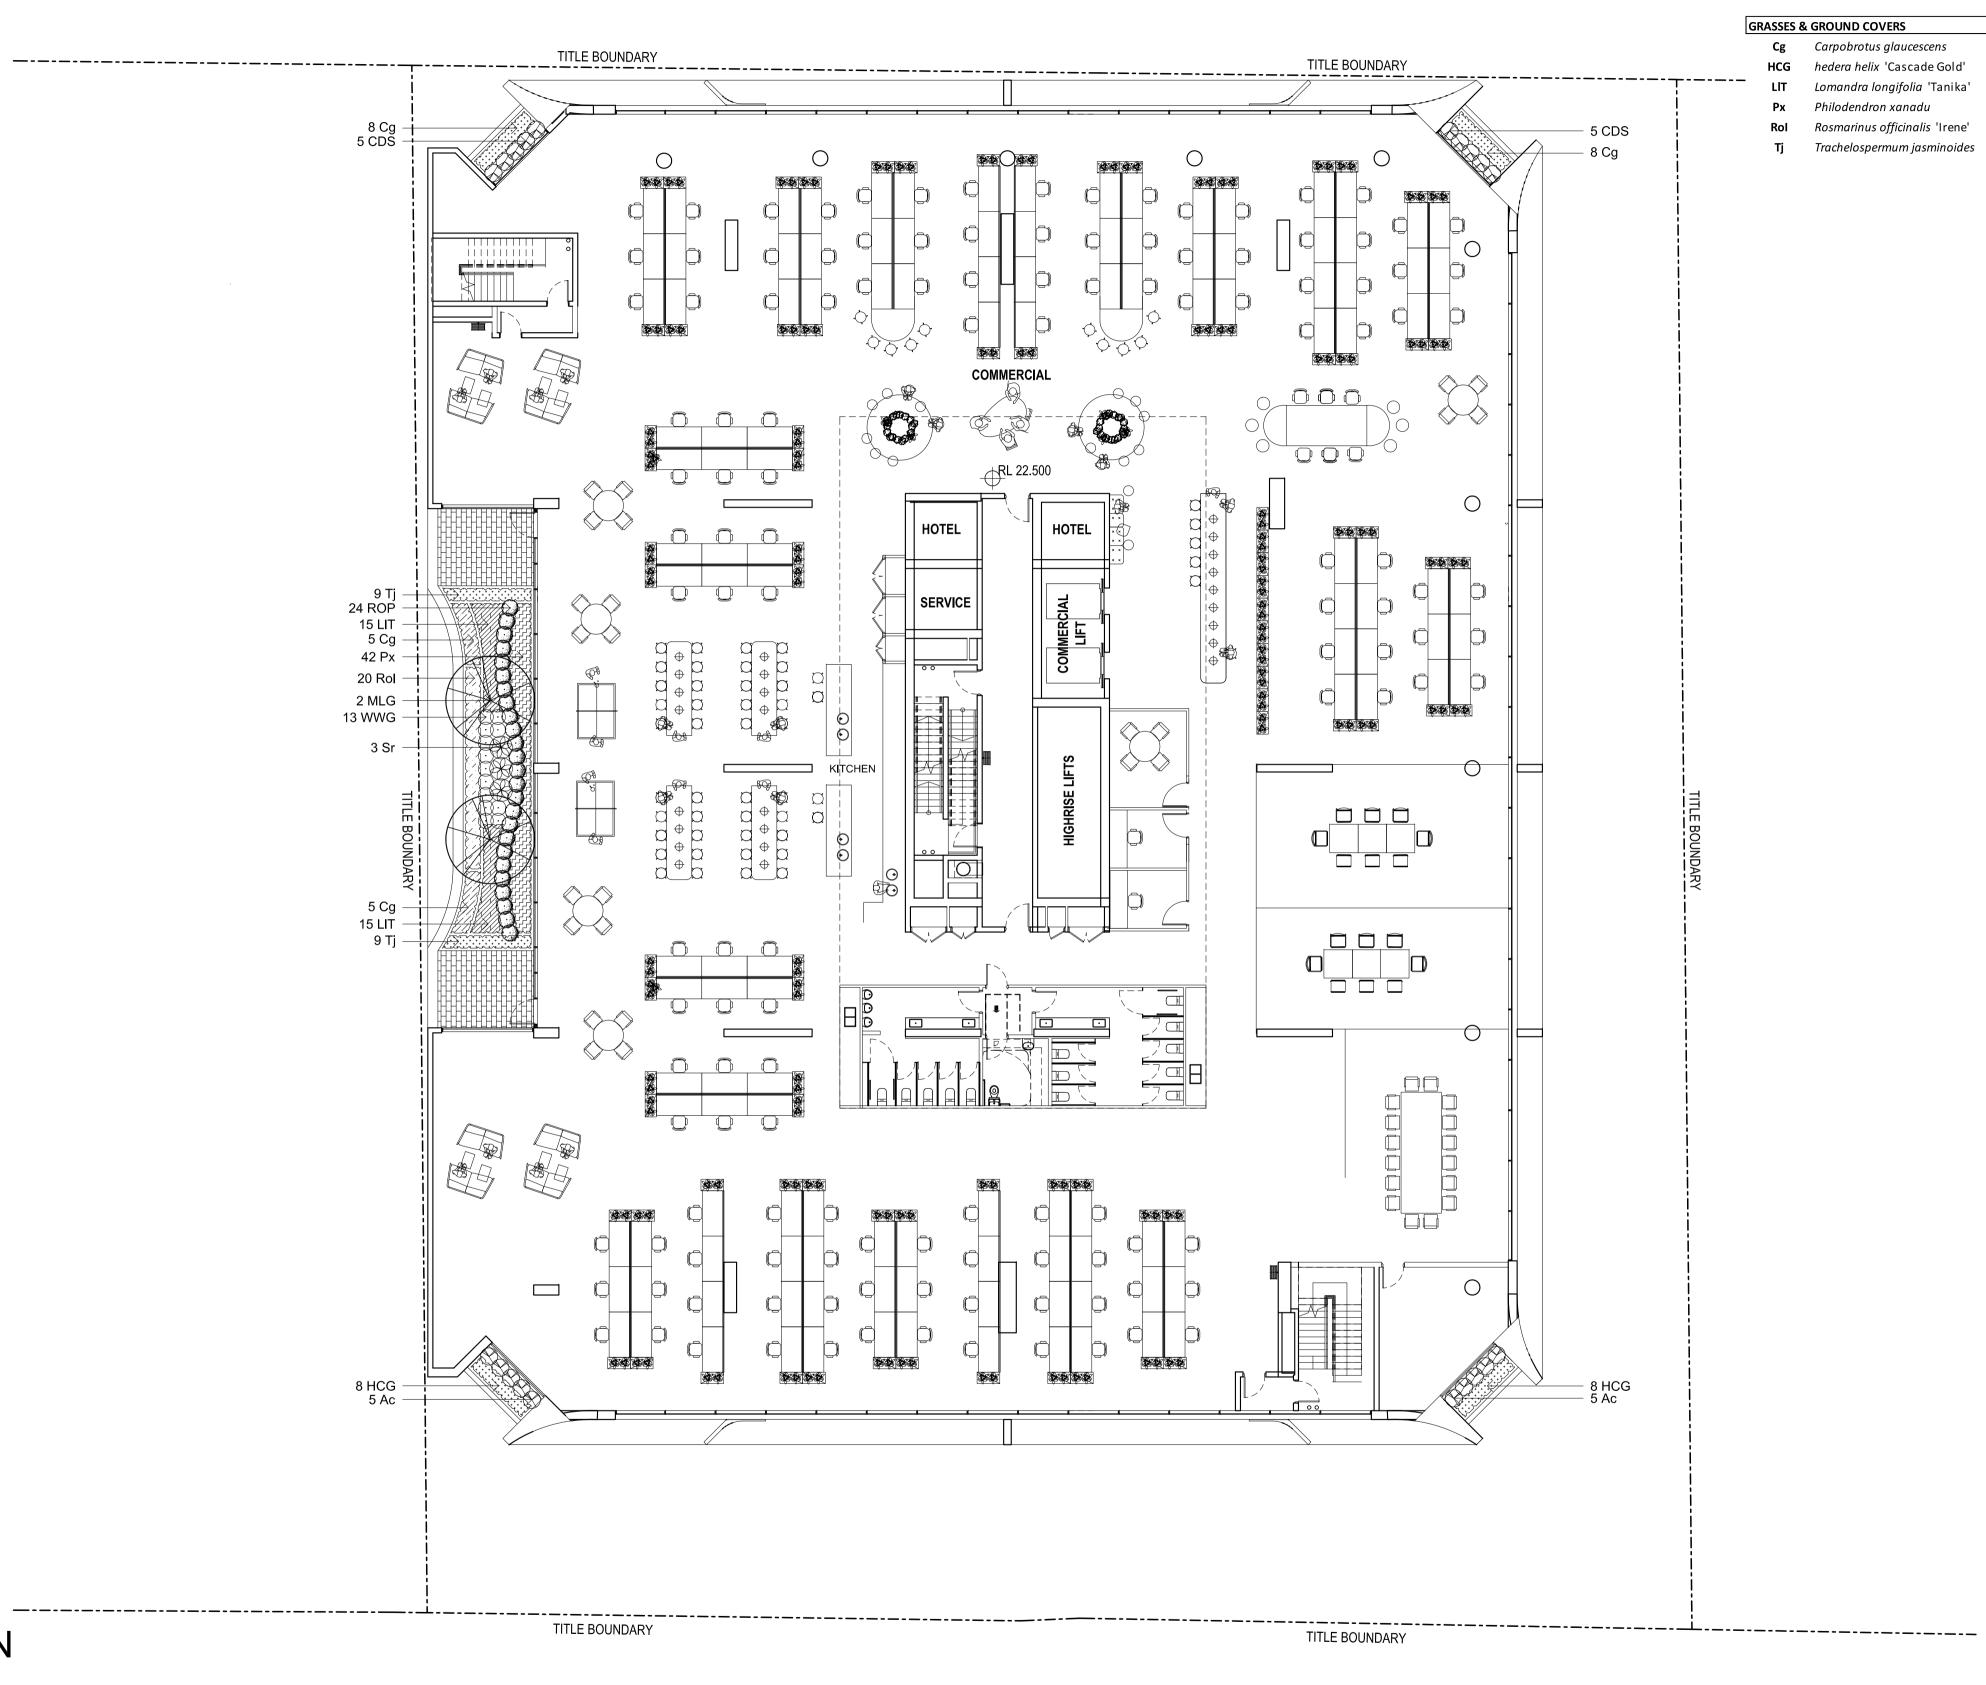

26 Elizabeth Street, Liverpool

Abbrev.	Botanic Name	Common Name	Mature Size	Pot Size	Density	Qty
LEVEL 2						
TREES						
MLG	Magnolia grandiflora 'Little Gem'	Dwarf Magnolia	5.0 x 3.0	200L	As Shown	2
SHRUBS &	ACCENTS					
Ac	Arthropodium cirratum	New Zealand Rock Lilly	0.6 x 1.0	300mm	As Shown	10
CDS	Carissa macrocarpa 'Desert Star'	Natal Plum	1.5 x 1.5	300mm	As Shown	10
Sr	Strelitzia reginae	Bird Of Paradise	1.5 x 1.5	300mm	As Shown	3
ROP	Rhapiopelis indica 'Oriental Pearl'	Indian Hawthorn	1.5 x 1.5	300mm	As Shown	24
WWG	Westringia fruticosa 'Wynyabbie Gem'	Coastal Rosemary	1.2 x 1.2	300mm	As Shown	13
GRASSES 8	& GROUND COVERS					
Cg	Carpobrotus glaucescens	Pig Face	0.3 x 2.0	200mm	5/m² or 2/LM	26
HCG	hedera helix 'Cascade Gold'	Variegated English Ivy	0.2 x 6.0	200mm	5/m² or 2/LM	16
LIT	<i>Lomandra longifolia</i> 'Tanika'	Mat Rush	0.8 x 0.8	200mm	5/m <sup>2</sup> or 2/LM	30
Px	Philodendron xanadu	Xanadu	1.2 x 1.2	200mm	5/m <sup>2</sup> or 2/LM	42
Rol	Rosmarinus officinalis 'Irene'	Prostrate Rosemary	0.3 x 1.5	200mm	5/m <sup>2</sup> or 2/LM	20
Tj	Trachelospermum jasminoides	Star Jasmine	0.3 x 1.5	200mm	5/m² or 2/LM	18

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LEGEND Proposed Tree (Refer Planting Schedule) Proposed Accent & Shrubs
(Refer Planting Schedule) 600 x 300 Unit Paver 150 x 150 Unit Paver

Proposed Groundcover / Grass Render & Painted (Refer Planting Schedule) Blockwork Wall

Concrete Bench Seat

Surface Indicators

TGSI - Tactile Ground

Key Plan:

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Rothelowman Architects 26 Elizabeth Street Liverpool NSW 2170

Drawing Name: Landscape Plan Level 2


DEVELOPMENT APPLICATION

Job Number: SS20-4354 L-102 A

A For DA Approval Issue Revision Description

100 x 100 Unit Paver

#### 26 Elizabeth Street, Liverpool Abbrev. Botanic Name **Common Name** Mature Size Pot Size Density SHRUBS & ACCENTS **Ac** Arthropodium cirratum New Zealand Rock Lilly 0.6 x 1.0 As Shown CDS Carissa macrocarpa 'Desert Star' Natal Plum 1.5 x 1.5 300mm As Shown GRASSES & GROUND COVERS 5/m<sup>2</sup> or 2/LM 16 **Cg** Carpobrotus glaucescens 0.3 x 2.0 Pig Face **HCG** hedera helix 'Cascade Gold' 0.2 x 6.0 200mm 5/m<sup>2</sup> or 2/LM 16 Variegated English Ivy

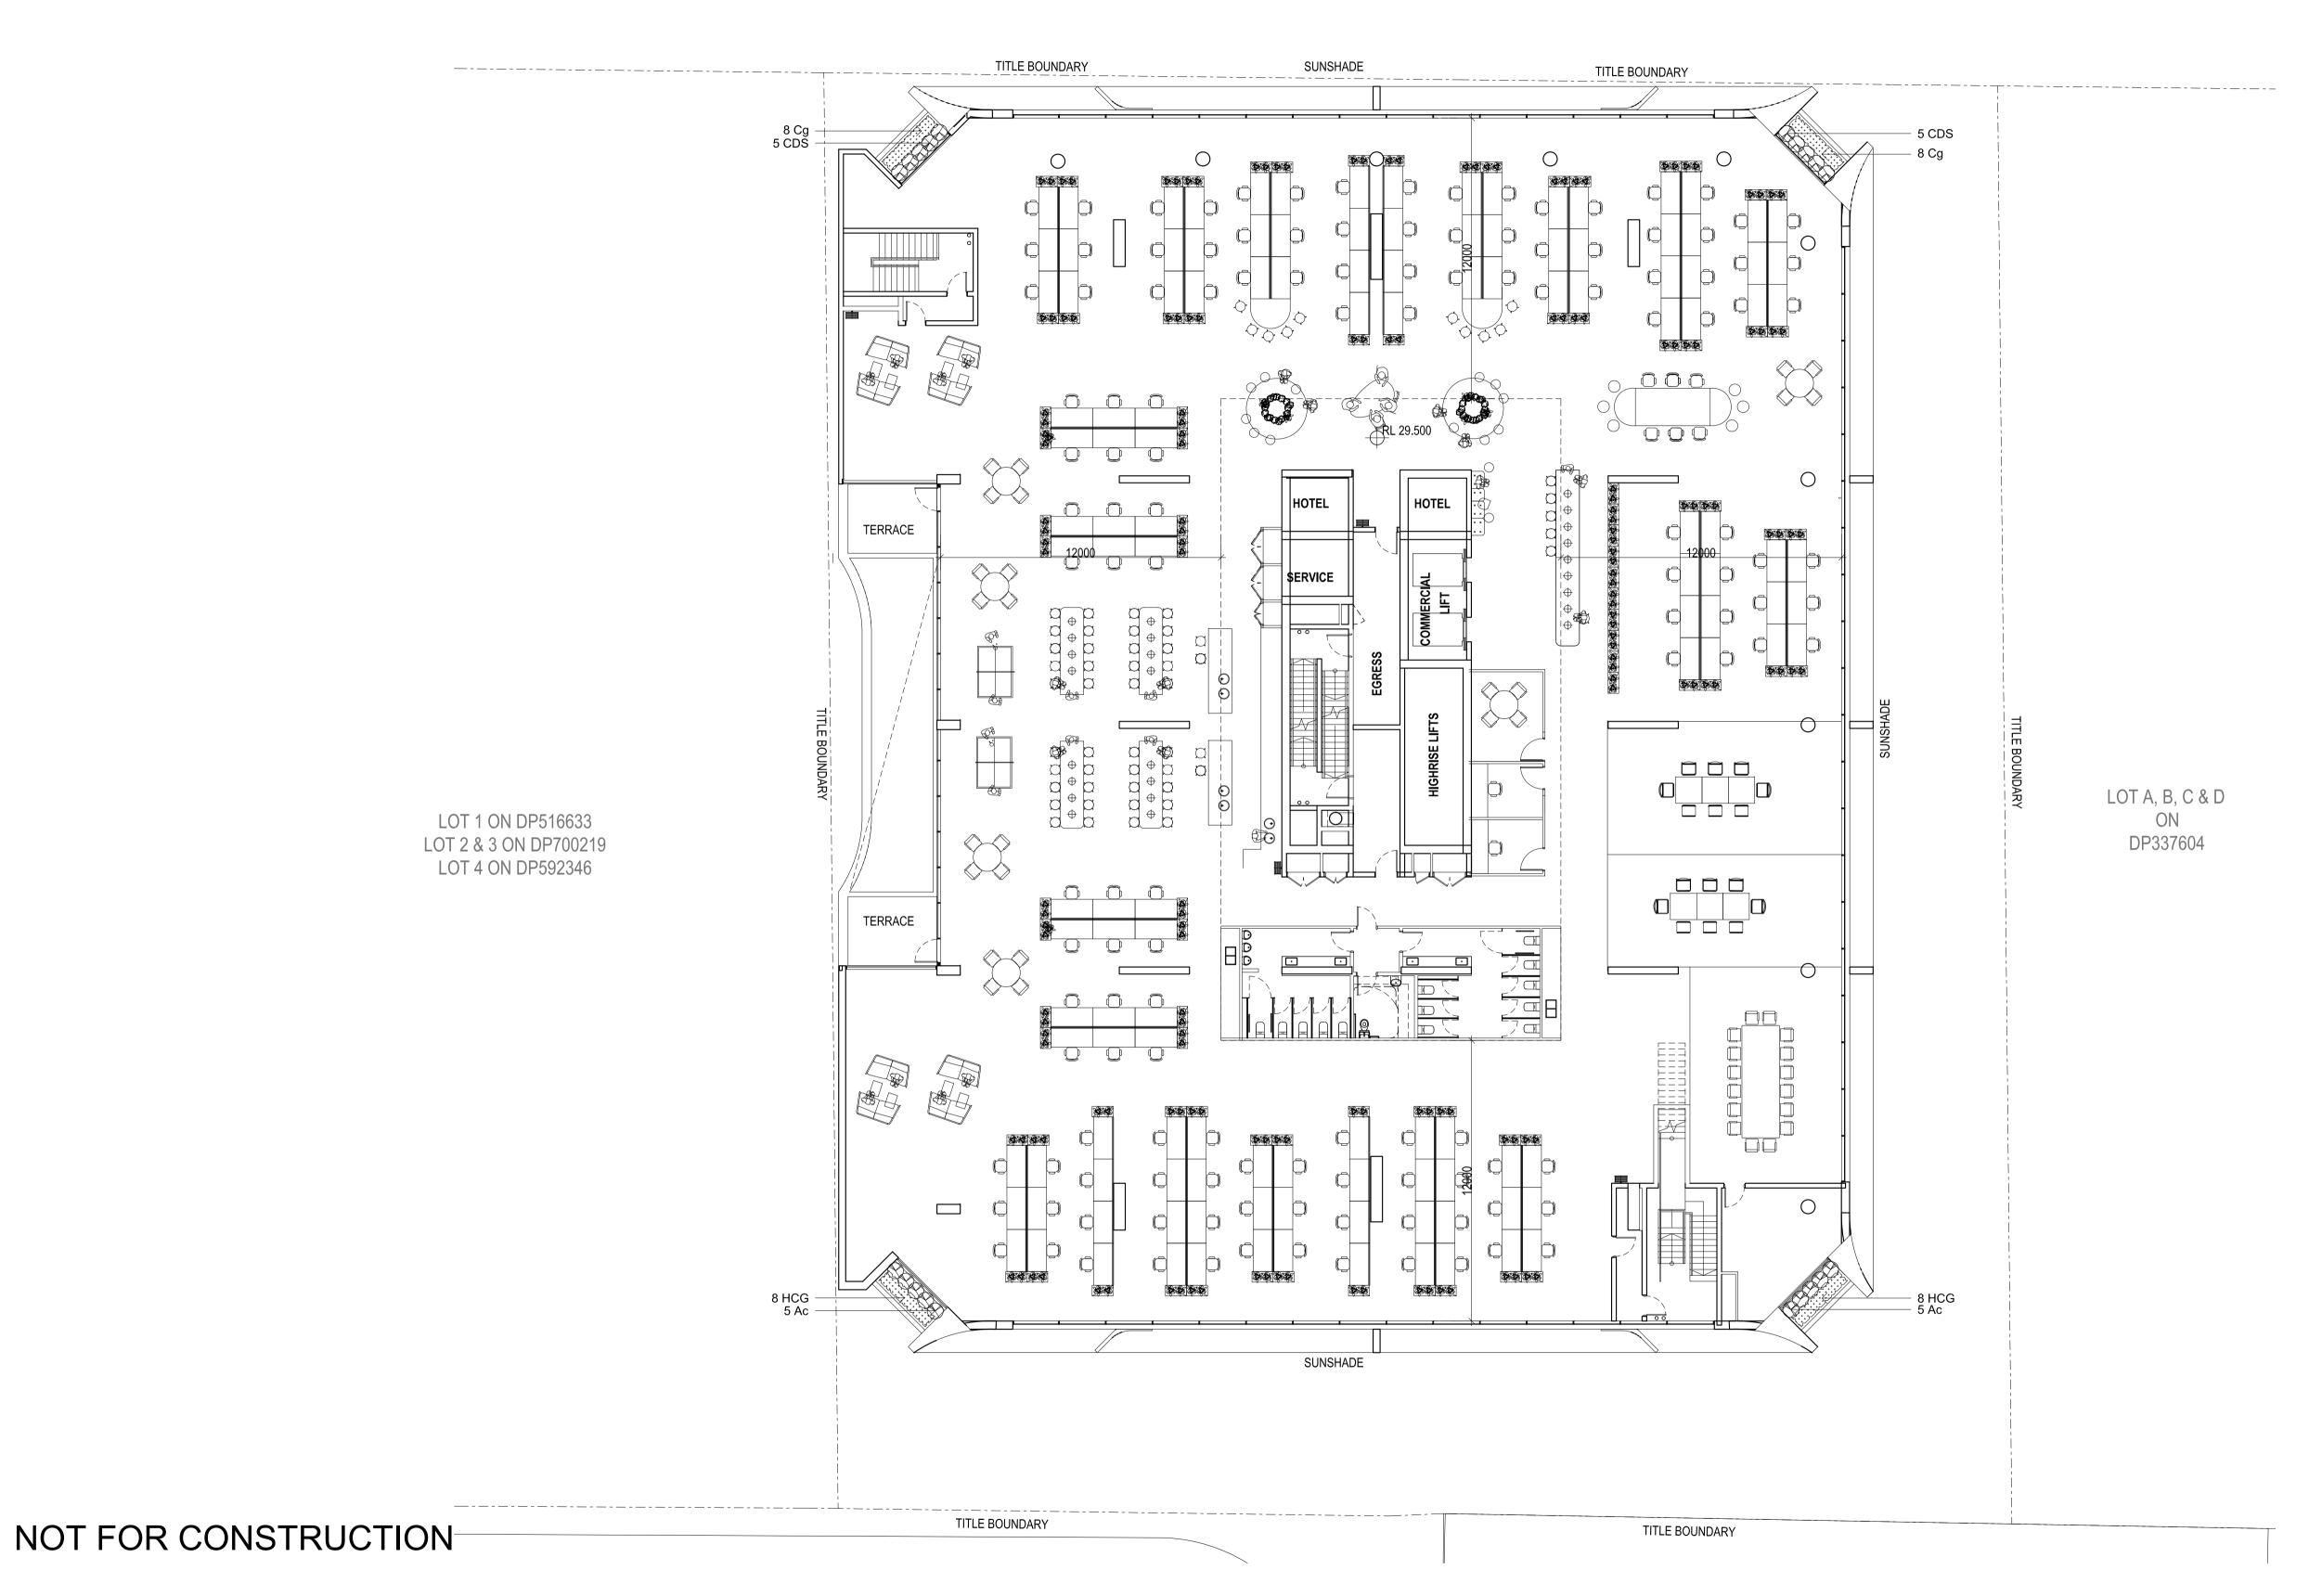

Key Plan:

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Issue Revision Description

Proposed Tree (Refer Planting Schedule) Proposed Accent & Shrubs
(Refer Planting Schedule) ☐ 600 x 300 Unit Paver 150 x 150 Unit Paver 100 x 100 Unit Paver

Drawn Check Date

LEGEND Concrete Bench Seat Proposed Groundcover / Grass Render & Painted (Refer Planting Schedule) Blockwork Wall TGSI - Tactile Ground Surface Indicators

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Liverpool NSW 2170


Drawing Name: Landscape Plan Level 3

DEVELOPMENT APPLICATION

Job Number: SS20-4354 L-103 A

### 26 Elizabeth Street, Liverpool

VEL 4 RUBS & ACCENTS	POL SIZE	Density	Qty
			Per Floor
A A.I. II			
Ac Arthropodium cirratum New Zealand Rock Lilly 0.6 x 1.0	300mm	As Shown	10
CDS Carissa macrocarpa 'Desert Star' Natal Plum 1.5 x 1.5	300mm	As Shown	10
ASSES & GROUND COVERS			
Cg Carpobrotus glaucescens Pig Face 0.3 x 2.0	200mm	5/m <sup>2</sup> or 2/LM	16
HCGhedera helix 'Cascade Gold'Variegated English Ivy0.2 x 6.0	200mm	5/m <sup>2</sup> or 2/LM	16

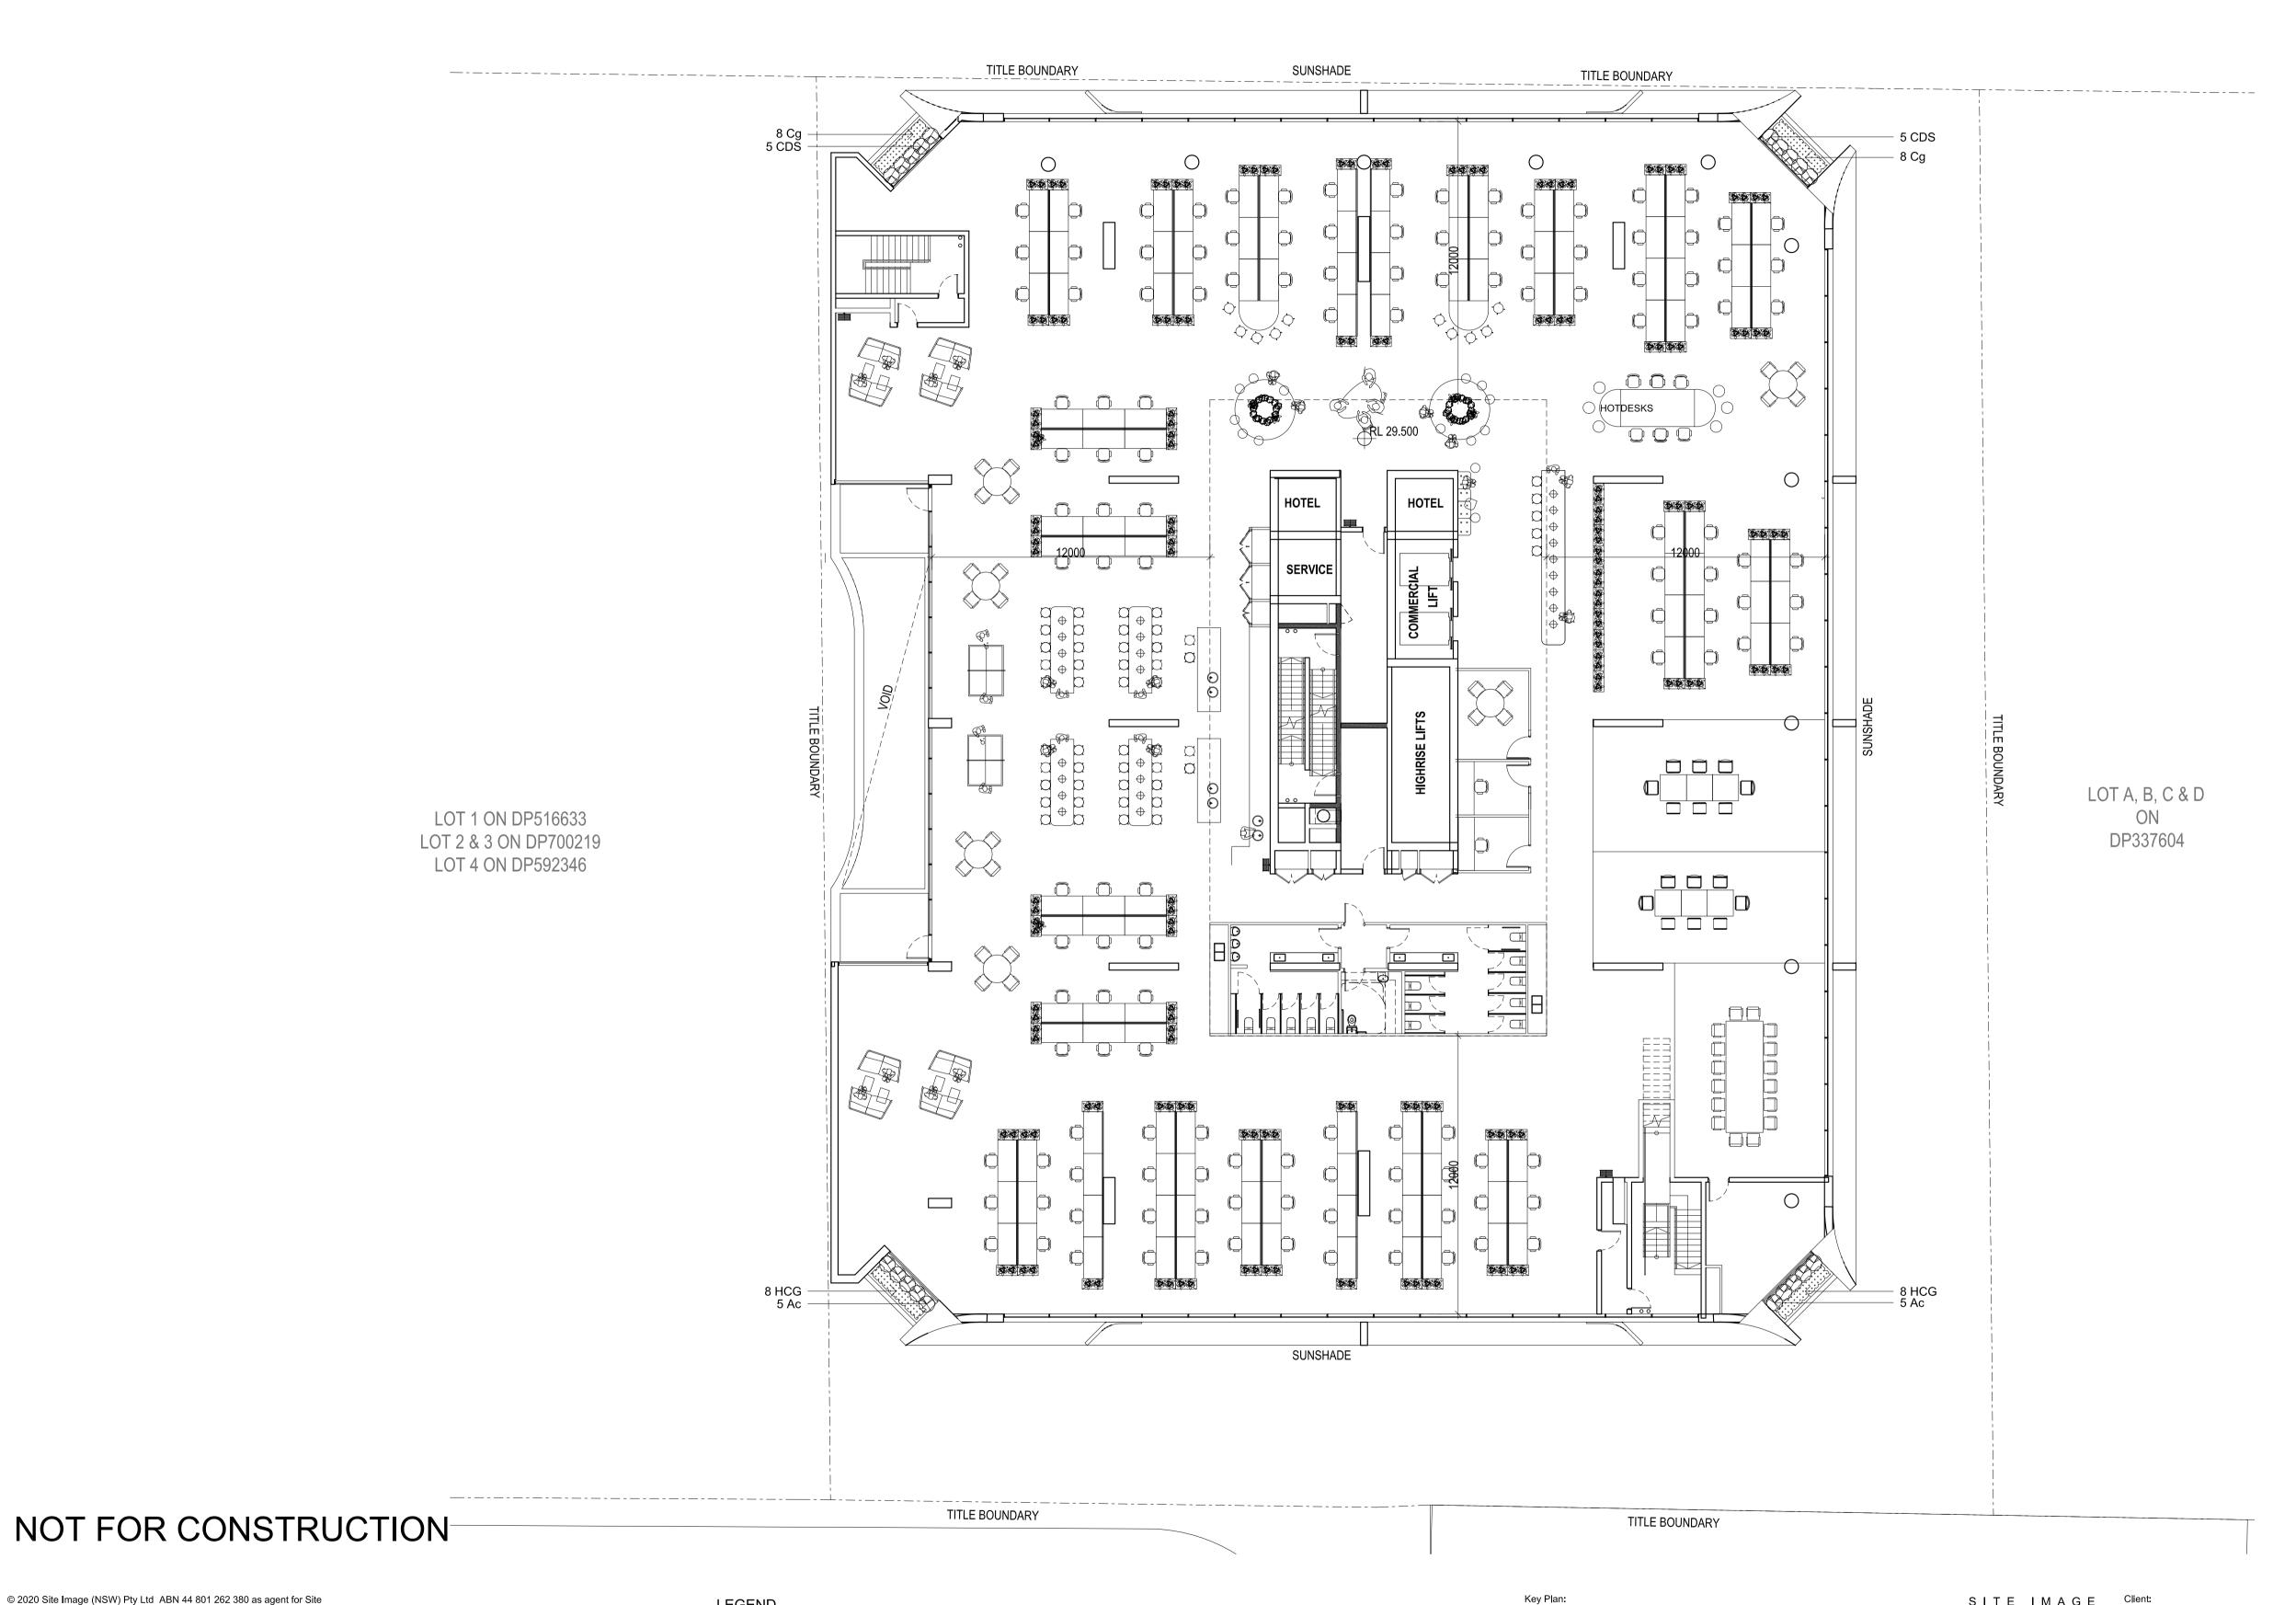

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A For DA Approval

Issue Revision Description

100 x 100 Unit Paver

Drawn Check Date

LEGEND Proposed Tree (Refer Planting Schedule) Proposed Accent & Shrubs
(Refer Planting Schedule) Proposed Groundcover / Grass Render & Painted (Refer Planting Schedule) Blockwork Wall 600 x 300 Unit Paver

150 x 150 Unit Paver

Concrete Bench Seat TGSI - Tactile Ground Surface Indicators

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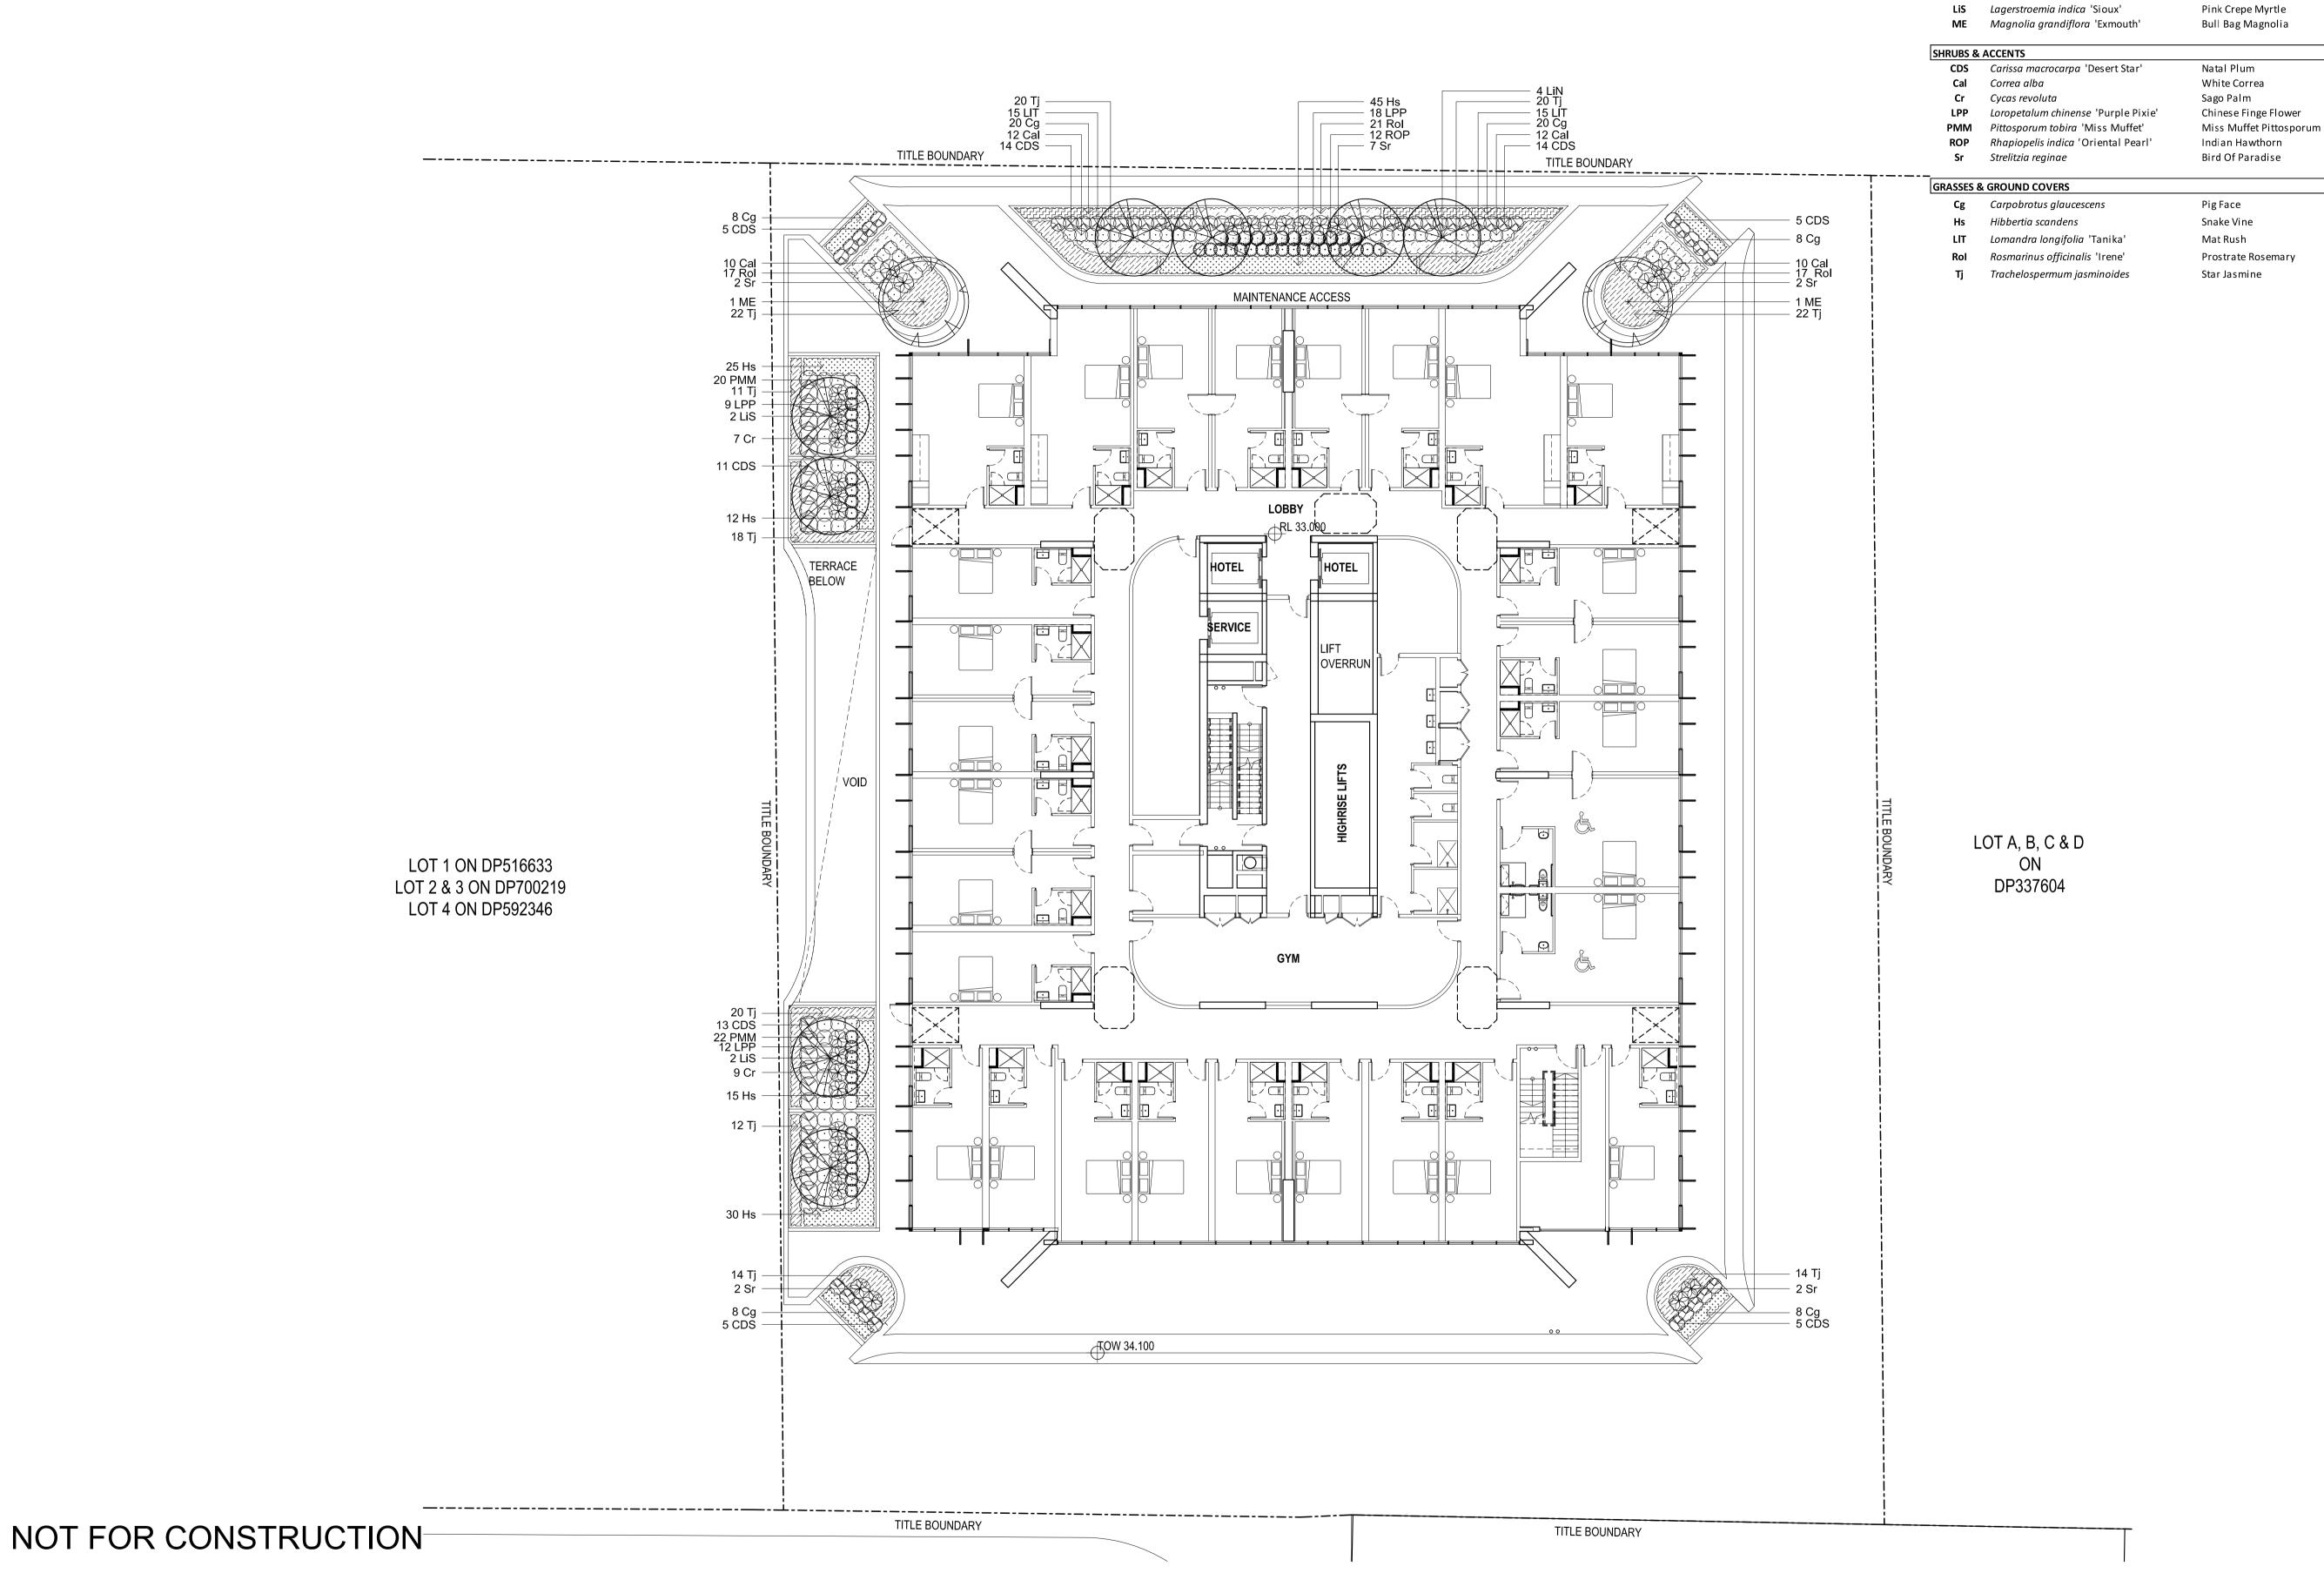
**BINAH Developments** 

Liverpool NSW 2170

Drawing Name: Landscape Plan Level 4

DEVELOPMENT APPLICATION

Job Number: SS20-4354 L-103 A



Key Plan:

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Proposed Accent & Shrubs
(Refer Planting Schedule) ☐ 600 x 300 Unit Paver 150 x 150 Unit Paver 100 x 100 Unit Paver

LEGEND Proposed Tree (Refer Planting Schedule) Concrete Bench Seat Proposed Groundcover / Grass Render & Painted (Refer Planting Schedule) Reckwork Wall TGSI - Tactile Ground Surface Indicators

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BINAH Developments Rothelowman Architects

26 Elizabeth Street, Liverpool

Lagerstroemia indica 'Natchez'

**Common Name** 

White Crepe Myrtle

Mature Size

6.0 x 4.0

6.0 x 4.0

15.0 x 8.0

1.5 x 1.5

1.0 x 1.0

1.0 x 1.5

0.6 x 1.5

1.0 x 1.0

1.5 x 1.5

1.5 x 1.5

0.3 x 2.0

0.3 x 1.0

 $0.8 \times 0.8$ 

0.3 x 1.5

0.3 x 1.5

Pot Size

200L

200L

200L

Density

As Shown

5/m<sup>2</sup> or 2/LM 72

5/m<sup>2</sup> or 2/LM 127

5/m<sup>2</sup> or 2/LM 30

5/m<sup>2</sup> or 2/LM 55

5/m<sup>2</sup> or 2/LM 173

Abbrev. Botanic Name

26 Elizabeth Street Liverpool NSW 2170

Drawing Name: Landscape Plan Level 5

DEVELOPMENT APPLICATION

Job Number: SS20-4354 L-105 A

TITLE BOUNDARY TITLE BOUNDARY 25 Cg8 CDS22 LIT - 27 ROP 5 Sn 3 CRS \_\_\_\_\_\_ 15 GaF 30 Hs 4 Cr 8 Req 28 Tj RESPECTA - 8 St 7 LEG 3 Sr 18 LPP - 12 Tj 18 RSM 7 LEG - 11 LEG OVERRUN OVERRUN - 12 RSM 7 LEG 10 Tj 1 MLG 3 Sr 12 Tj 9 LPP - 11 LEG OVERRUN 29 ROP 7 LEG 16 VDF 1 LiN 20 GaF 20 LIT 12 Dr 11 Px 10 Dr 4 Cr 8 Cal 4 Sr 15 Px - 22 LIT POOL 15 Px - 12 Dr 11 Px 10 Dr - 1 LiN LOT 1 ON DP516633 8 Cal LOT 2 & 3 ON DP700219 10 Tj 7 LEG 30 ROP 11 LEG 12 RSM LOT 4 ON DP592346 3 Sr 18 Px 9 LPP 11 LEG 12 Tj 25 Dr **31 ROP** 7 LEG - 12 St 30 Hs 4 Cr 15 GaF 3 CRS 5 Sn 6 Req 15 Px 2 LiS 20 An 22 Px - 8 Ae - 25 Hs 8 Ae 4 Ac 2 Aa - 4 Ac - 25 Hs - 2 Re 8 Ae22 Px2 Aa TELE DOLUMBARY TITLE BOUNDARY

26 Elizabeth Street, Liverpool

Density **Common Name Mature Size** Pot Size Lagerstroemia indica 'Natchez' White Crepe Myrtle 6.0 x 4.0 200L As Shown Lagerstroemia indica 'Sioux' 200L As Shown Pink Crepe Myrtle 6.0 x 4.0 MLG Magnolia grandiflora 'Little Gem' Dwarf Magnolia 5.0 x 3.0 200L As Shown SHRUBS & ACCENTS **Ac** Arthropodium cirratum New Zealand Rock Lilly 0.6 x 1.0 300mm As Shown Asplenium australasicum Birds Nest Fern 1.0 x 1.5 300mm As Shown 2.0 x 2.0 300mm As Shown Beschorneria yuccoides Mexican Lily Carissa macrocarpa 'Desert Star' Natal Plum 1.5 x 1.5 As Shown Cordyline fruticosa 'Red Sensation' Cordyline 1.5 x 1.0 300mm As Shown 1.0 x 1.0 300mm Correa alba White Correa As Shown Cycas revoluta Sago Palm 1.0 x 1.5 As Shown Gymea Lilly 2.0 x 2.0 As Shown Gardenia augusta 'Florida' Gardenia 1.2 x 1.0 As Shown Loropetalum chinense 'Purple Pixie' Chinese Finge Flower 0.6 x 1.5 300mm As Shown Rhapiopelis indica 'Oriental Pearl' Indian Hawthorn 1.5 x 1.5 300mm As Shown Rhapiopelis indica 'Oriental Pearl' Indian Hawthorn  $0.6 \times 0.6$ 300mm As Shown Lady Palm 300mm As Shown 3.0 x 2.0 **Coral Plant** 300mm Russelia equisetiformis 1.8 x 0.6 As Shown Sanserveria trifasciata Mother-In-Laws Tongue  $1.2 \times 0.5$ As Shown Giant Bird Of Paradise 3.0 x 2.0 As Shown Bird Of Paradise 1.5 x 1.5 300mm As Shown Strelitzia reginae Sweet Viburnum 1.5 x 1.5 300mm As Shown Viburnum odoratissimum 'Dense Fence' **GRASSES & GROUND COVERS** Dwarf Cardamon 1.5 x 1.0 5/m<sup>2</sup> or 2/LM Aspidistra elatior Cast Iron Plant  $1.2 \times 1.0$ 5/m<sup>2</sup> or 2/LM Pig Face  $0.3 \times 2.0$ 5/m<sup>2</sup> or 2/LM Dichondra repens Kidney Weed  $0.1 \times 0.5$ 5/m<sup>2</sup> or 2/LM Snake Vine 0.3 x 1.0 5/m<sup>2</sup> or 2/LM 115 Liriope muscari 'Evergreen Giant' Turf Lilly 0.6 x 0.6 Lomandra longifolia 'Tanika' Mat Rush Philodendron xanadu Xanadu 1.2 x 1.2 5/m<sup>2</sup> or 2/LM Rosmarinus officinalis 'Irene' Prostrate Rosemary 0.3 x 1.5 5/m<sup>2</sup> or 2/LM 5/m<sup>2</sup> or 2/LM 144 Trachelospermum jasminoides Star Jasmine

LOT A, B, C & D ON DP337604

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A For DA Approval

Issue Revision Description

LEGEND Proposed Tree (Refer Planting Schedule) Concrete Bench Seat Proposed Accent & Shrubs (Refer Planting Schedule) Proposed Groundcover / Grass
(Refer Planting Schedule) Render & Painted Blockwork Wall TGSI - Tactile Ground ☐ 600 x 300 Unit Paver Surface Indicators 150 x 150 Unit Paver 100 x 100 Unit Paver

Key Plan:



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SITE IMAGE **BINAH Developments** 

Rothelowman Architects

26 Elizabeth Street Liverpool NSW 2170

Drawing Name: Landscape Plan Level 9

**DEVELOPMENT APPLICATION** 

Job Number:

SS20-4354

L-106 A

### SPECIFICATION

#### **GENERAL NOTES**

#### References

All plans and details included in the project documents shall be read in conjunction with this specification. All structural and civil works components of the landscape design shall be referenced to engineers' details and specifications. Read this specification in conjunction with the plant and materials schedules on the drawings. If in doubt about any detail or if conflicts are found in the documents, seek advice.

#### **Workmanship and Materials**

The whole of the landscape works shall be carried out by a competent, trained and qualified landscape contractor who is experienced in horticultural practices, landscape construction and planting techniques. The landscape contractor shall hold a current Building Contractors License and/or be a financial member of LNA Landscape Association NSW & ACT or equivalent organisations in other states.

#### **HARDWORKS**

#### Furniture, Handrails, Balustrades

Supply and install the scheduled items in accordance with the manufacturer's recommendations, as detailed and in the locations shown on plan. Provide all footings and fixings required for the items to be stable and in accordance with applicable codes and standards.

#### Garden Walls, Fences, Steps, TGSI and Edging

Construct garden walls, fences, steps, TGSI and edging as shown on plan, as detailed and of the material scheduled. Provide footings, step nosings, tactile surfaces to comply with standards and applicable legislation. Refer to engineer's details for structural retaining walls, heavy duty slabs, concrete stairs, concrete strength, reinforcing and joint placement.

#### Continuous, Unit and Loose Pavement

Install the scheduled material pavement to the locations shown on plan. Ensure that all subgrade/subsurface works are complete prior to commencing paving. Confer with the engineer to ensure the structural integrity of the subgrade. Ensure that the base course under paved surfaces is a continuous plane offering a constant depth of bedding material not exceeding 50mm.

#### **SOFTWORKS**

Soil Testing Where site soil is to be retrieved from and stored for reuse on site, undertake at least two (2) soil tests, in locations as advised by the Project Manager. Provide results and recommendations regarding soil additives for the benefit of healthy plant growth and to adjust the soil components to achieve an appropriate planting medium for successful plant development.

#### Subsoil

Excavate and/or fill all garden beds to bring the top of subsoil to at least 300mm below finished design soil levels. Excavate all turf areas to bring the subsoil to at least 100mm below finished design levels. In all areas shape the subsoil to fall to subsoil drains where applicable. Do not excavate within the drip line of trees and shrubs to be retained. Cultivate or rip the subsoil to a further depth of 100mm before placing top soil. Remove stones of size exceeding 25mm, clods of earth exceeding 50mm, and weeds, rubbish or other deleterious material brought to the surface during cultivation. Do not disturb services or existing tree roots. If necessary cultivate these areas by hand. During cultivation, thoroughly mix in materials required to be incorporated into the subsoil, as recommended in the soil testing results and to manufacturer's recommendations. Trim the surface to design levels again after cultivation.

### Topsoil

Import topsoil for the garden and turf areas, unless the topsoil can be provided from material recovered from the site, as recommended in the soil testing results. Spread the topsoil on the prepared subsoil and grade evenly, compact lightly and uniformly in 150mm layers. Avoid differential subsidence and excess compaction and produce a finished topsoil surface which has the following characteristics:

- Finished to design levels, allowing for mulch or turf, which is to finish flush with adjoining hard surfaces such as paths and edges;
- Smooth and free from inorganic matter, stones or clods of soil;
- Graded to drain freely, without ponding, to catchment and/or sub-soil drains;
- Graded evenly to adjoining surfaces; and
- Ready for planting.

### Compost

Provide, in accordance with AS 4454, well rotted vegetative material or animal manure, free from harmful chemicals, inorganic matter, grass, weeds and the reproductive parts of unwanted plants.

### **Fertiliser**

Α1

Provide proprietary fertilisers, delivered to the site in sealed containers marked to show manufacturer or vendor, weight, fertiliser type, N:P:K ratio, recommended uses, application rates and safety procedures. Apply appropriate fertiliser suited to the provenance of plants (indigenous or exotic) included in the design.

#### **Plants**

Supply plants in accordance with the landscape design drawings and schedules, which have the following characteristics:

- Large healthy root systems, with no evidence of root curl, restriction or damage;
- Vigorous, well established, free from disease and pests, of good form consistent with
- Hardened off, not soft or forced, and suitable for planting in the natural climatic conditions prevailing at the site in full sun, partial shade or full shade conditions;
- Grown in final containers for not less than twelve weeks;
- Trees, unless required to be multi-stemmed, shall have a single leading shoot; and
- Containers shall be free from weeds and of appropriate size in relation to the specified plant size.

#### Plant Installation

Following excavation of the planting hole, place and spread 15gms of wetting agent pre-mixed with one (1) litre of water. Place the plant correctly orientated to north or for best presentation. Backfill the planting holes with specified topsoil mixture. Lightly tamp and water to eliminate air pockets. Ensure that the backfill soil is not placed over the top of the root ball and that the root ball is not higher than the soil in which it is planted. Apply fertiliser, as specified around the plants in the soil at the time of planting.

#### Root Barrier

Supply and install root control barriers to all new tree plantings adjacent to walls, paths, kerbs and all service trenches, where their proximity poses a threat to the stability of the built infrastructure. Install in accordance with manufacturer's recommendations.

Unless noted otherwise, mulch shall be approved proprietary recycled wood fibre or pine bark material. Place mulch in all garden beds to a depth of 75mm after all specified plants are installed. Keep mulch clear of all plant stems and rake to an even plane, flush with the surrounding surfaces evenly graded between design surface levels. Over fill to allow mulch to settle to the specified depth.

Stakes shall be durable hardwood, straight, free of knots and twists, pointed at one end. in the following quantities and sizes for each of the various plant pot sizes:

- Plants (>25 lt): 1 off 38 x 38 x 1200mm;
- Semi-advanced plants (>75 lt): 2 off 50x50x 1800mm;
- Advanced (>100 lt): 3 off 50 x 50 x 2400mm.

Turf shall be delivered to site as 25mm minimum thick cut rolls. Obtain turf from a specialist grower of cultivated turf. Turf shall have an even thickness, free from weeds and other foreign matter. Deliver turf to the site within 24 hours of being cut and lay it within 24 hours of delivery. Prevent it form drying out between cutting and laying. Lay the turf in the following manner:

- In stretcher pattern, joints staggered and close butted;
- Parallel long sides of level areas, with contours on slopes; and
- To finish flush, after lightly tamping, with adjacent finished surfaces and design levels.

#### RRIGATION

All proposed landscape areas shall be irrigated.

The irrigation system shall be an automatic permanent system, with an irrigation controller self operated via a soil moisture sensor. The system shall be calibrated to deliver the optimum rate and volume of water appropriate to the type of plants in the design. The system shall be adjustable and fully serviceable. The layout of the entire irrigation system shall focus on delivering the required amount of water to maintain healthy and vigorous growth. The irrigation system shall be such that, component theft, vandalism, over-spray and wetting of paths shall be reduced to a minimum or completely eliminated by the use of drip, pop-up sprinklers and judiciously placed fixed spray emitters. Generally do not use fine mist emitters that provide a drifting mist that may wet paths and the buildings unless specifically required by the design.

### LANDSCAPE MAINTENANCE

The Landscape Contractor shall rectify defects during installation and that become apparent in the works under normal use for the duration of the contract Defects Liability Period. Unless contracted otherwise, the Landscape Contractor shall maintain the contract areas by the implementation of industry accepted horticultural practices for 52 weeks from Practical Completion of the works. The landscape maintenance works shall include, but not be limited to:

- Replacing failed plants;
- Pruning;
- Insect and pest control;
- Fertilising:
- Maintaining and removing stakes and ties;
- Maintaining mulch;
- Mowing and top dressing; Irrigation and watering;
- Erosion control; and
- Weeding and rubbish removal.

#### Maintenance Log Book

Implement and keep a maintenance log book recording when and what maintenance work has been undertaken and what materials, actions and decisions have been used, implemented and concluded to keep the landscape always looking its best. Enter data daily and review information every 2 weeks. Observe trends and develop a maintenance regime around seasonal and observed event occurrences.

#### Maintenance Activities

During the defects maintenance period schedule the following activities to occur on a timely basis.

- Plant replacement Replace plants that have failed to mature, die or are damaged. Replacement plants shall be in a similar size and quality and identical species or variety to the plant that has failed. Replacement of plants shall be at the cost of the landscape contractor unless advised otherwise. If the cause of the failure is due to a controllable situation then correct the situation prior to replacing plants. Observe and replace failed plants within 2 weeks of observation.
- **Pruning -** Prune dead wood, broken limbs, dead or infected foliage and as needed to develop strong, healthy plants to achieve the shape and form expected of the plant type. Observe daily and prune plants on a needs basis.
- Insect, disease and pest control Avoid spraying:
- if ever possible;
- in wet weather or if wet weather is imminent;
- if target plants are still wet after rain:
- in windy weather; and
- if non-target species are too close.

Immediately report to the Project Manager any evidence of intensive weed infestation, insect attack or disease amongst plant material. Submit all proposals to apply chemicals and obtain approval before starting this work. When approved, spray with herbicide, insecticide, fungicide as appropriate in accordance with the manufacturers' recommendations. Observe daily and act as necessary to control any infestation or disease. Record in the logbook all relevant details of spraying activities including:

- Product brand / manufacturer's name.
- Chemical / product name,
- Chemical contents,
- Application quantity and rate
- Date of application and location,
- Results of application, and
- Use approval authority.
- Fertilising Fertilise gardens with a proprietary slow release fertiliser applied in accordance with the manufacturer's directions and recommendations. Apply 6-12 monthly. Record in the logbook all relevant details of fertilising including:
- Product brand / manufacturer's name.
- Fertiliser / product name,
- Application quantity and rate, and
- Date of application and location.
- Stakes and ties Adjust and replace as required to ensure plants remain correctly staked. Remove those not required at the end of the planting establishment period (Defects Liability Period). Inspect and act at least every 2 weeks.
- Maintaining mulch Maintain the surface in a clean, tidy and weed free condition and reinstate the mulch as necessary to ensure correct depth as specified. Observe weekly and replenish mulch as required.
- Mowing and top dressing Mow the turf to maintain a grass height of between 30-50mm. Do not remove more than one third of the grass height at any one time. Remove grass clippings from the site after each mowing. Top dress to a maximum of 10mm to fill depressions and hollows in the surface. Mow weekly/fortnightly in warmer months. Mow monthly or as required in cooler months. Top dress at approximately 6 monthly intervals.
- Irrigation and watering Maintain the irrigation system to sure that each individual plant receives the required amount of water to maintain healthy and vigorous growth. Adjust and calibrate as required. Provide additional watering, if necessary but inspect irrigation weekly and make repairs as necessary. • Erosion control - Where necessary, maintain the erosion control fabric in a tidy and
- weed free condition and reinstate as necessary to ensure control measures are effective where deemed necessary. Inspect every 2 weeks and act to repair any damage as soon as possible. Weeding and rubbish removal - During the plant establishment period remove by

hand, rubbish and weed growth that may occur or re-occur throughout all planted, mulched and paved areas. The contractor shall target weeds that are capable of producing a major infestation of unwanted plants by seed distribution. Whenever possible, time weed removal to precede flowering and seed set. Constant observation and removal of weeds is essential.

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The contractor shall check and verify all work on site (including work by others) before commencing the landscape installation. Any discrepancies are to be reported to the Project Manager or Landscape Architect prior to commencing work. Do not scale this drawing. Any required dimensions not shown shall be referred to the Landscape Architect for confirmation.

> A For DA Approval NP RS 18.03.2020 Issue Revision Description Drawn Check

Landscape Architects Level 1, 3-5 Baptist Street Redfern NSW 2016 Australia

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SITE IMAGE

BINAH Developments

Rothelowman Architects 26 Elizabeth Street

Liverpool NSW 2170

Landscape Specification


DEVELOPMENT APPLICATION

Scale: 1:150 @ A1 Job Number:


Drawing Number:

SS20-4354


L-500 A

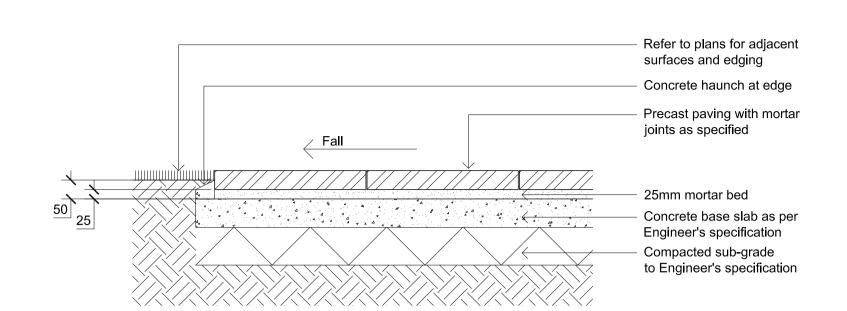

Precast Unit Pavers on Concrete Slab L-501

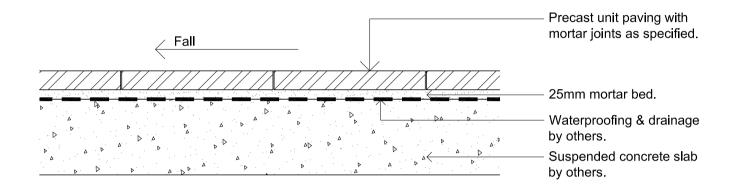


### Precast Unit Pavers on Suspended Slab 02 Pre

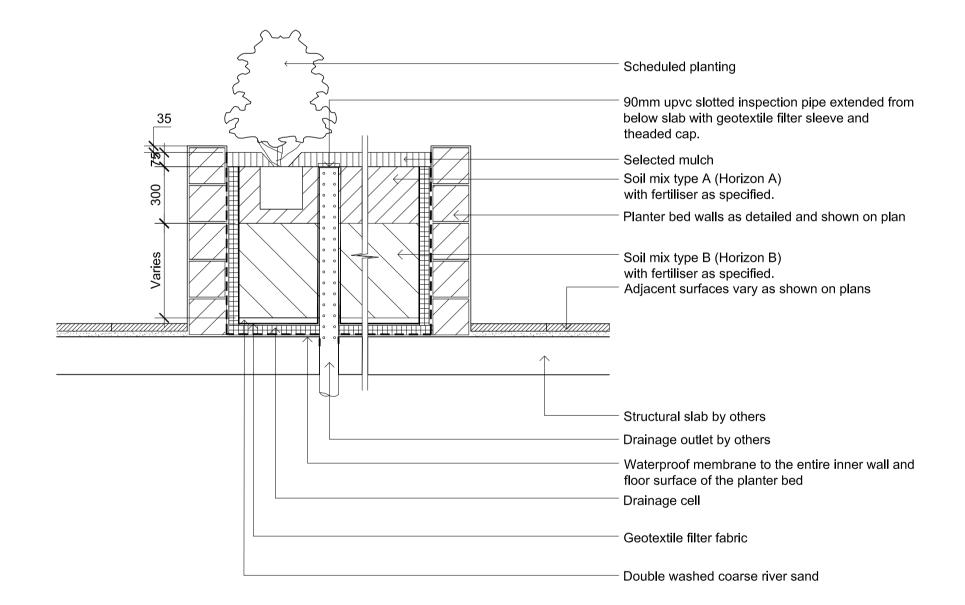

Section - Typical Raised Planter Bed on Structure 03 L-501 Inspection riser pipe


# Tree planting as plan & schedule Hession ties above lowest limb to prevent slipping Hardwood timber stakes. refer to specification for no. & size drive securely into ground and avoid root ball Mulch as specified Fertiliser as specified Topsoil mix type A Topsoil mix type B Refer specification Rip subgrade Install root barrier as required.

Detail 75-200L Tree Planting on Grade L-501 1:10

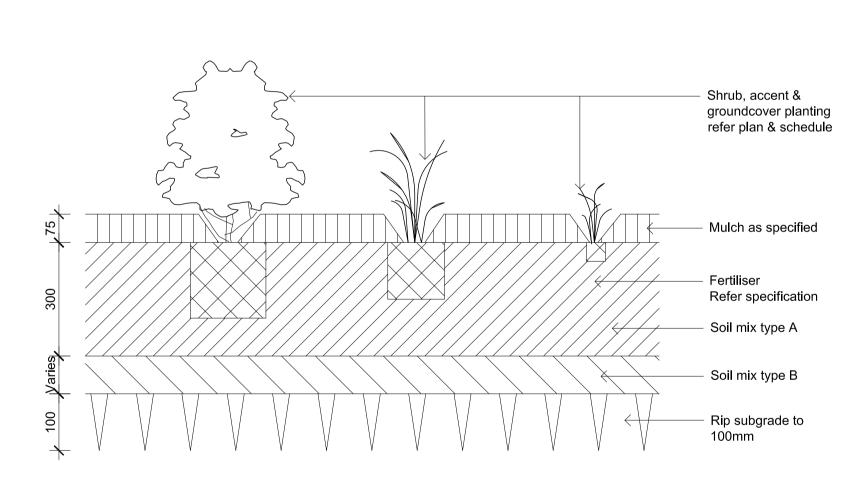


Refer specification.

Detail Shrub Accent & Groundcover Planting on Grade L-501 <sub>1:10</sub>

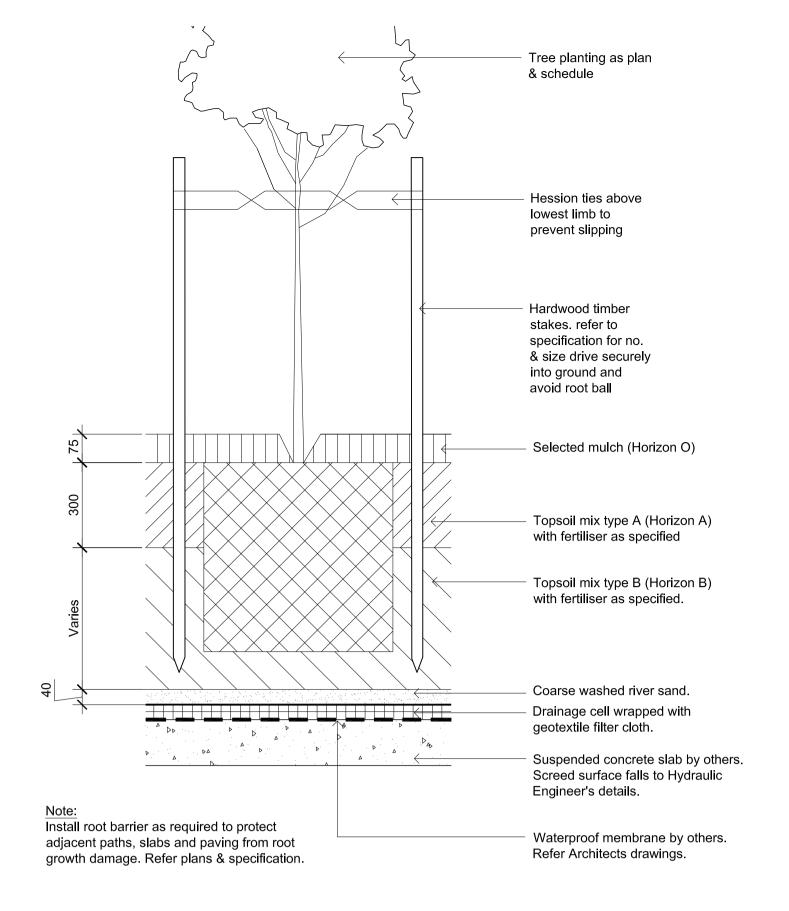

Detail 75-200L Tree Planting on Structure L-501 <sub>1:10</sub>

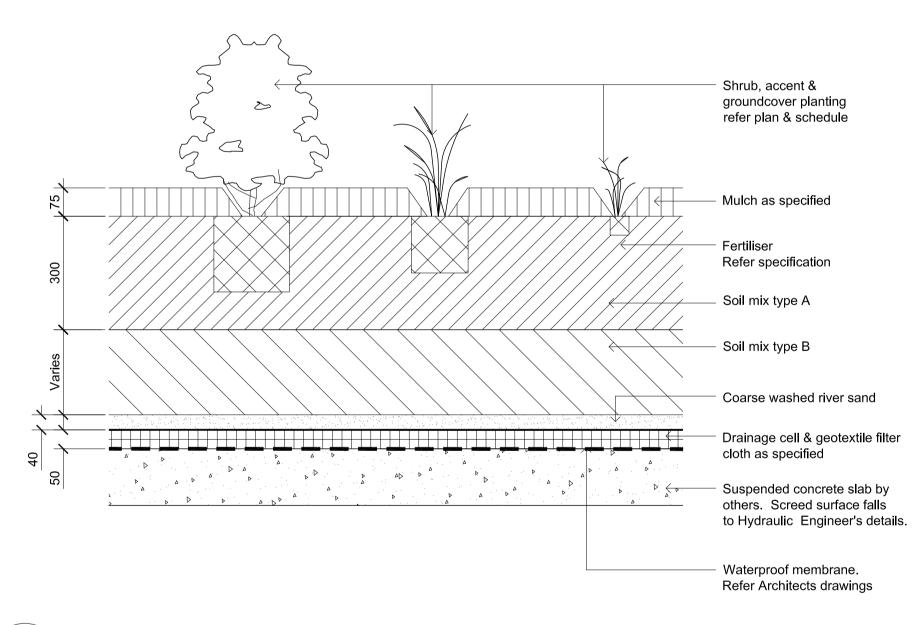

Detail Shrub Accent & Groundcover Planting on Structure L-501 / 1:10

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NP RS 18.03.2020

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**BINAH Developments** Rothelowman Architects


26 Elizabeth Street Liverpool NSW 2170 Drawing Name: Landscape Details

DEVELOPMENT APPLICATION

Scale: Varies


Job Number: L-501 A

SS20-4354 Issue Revision Description Drawn Check Date

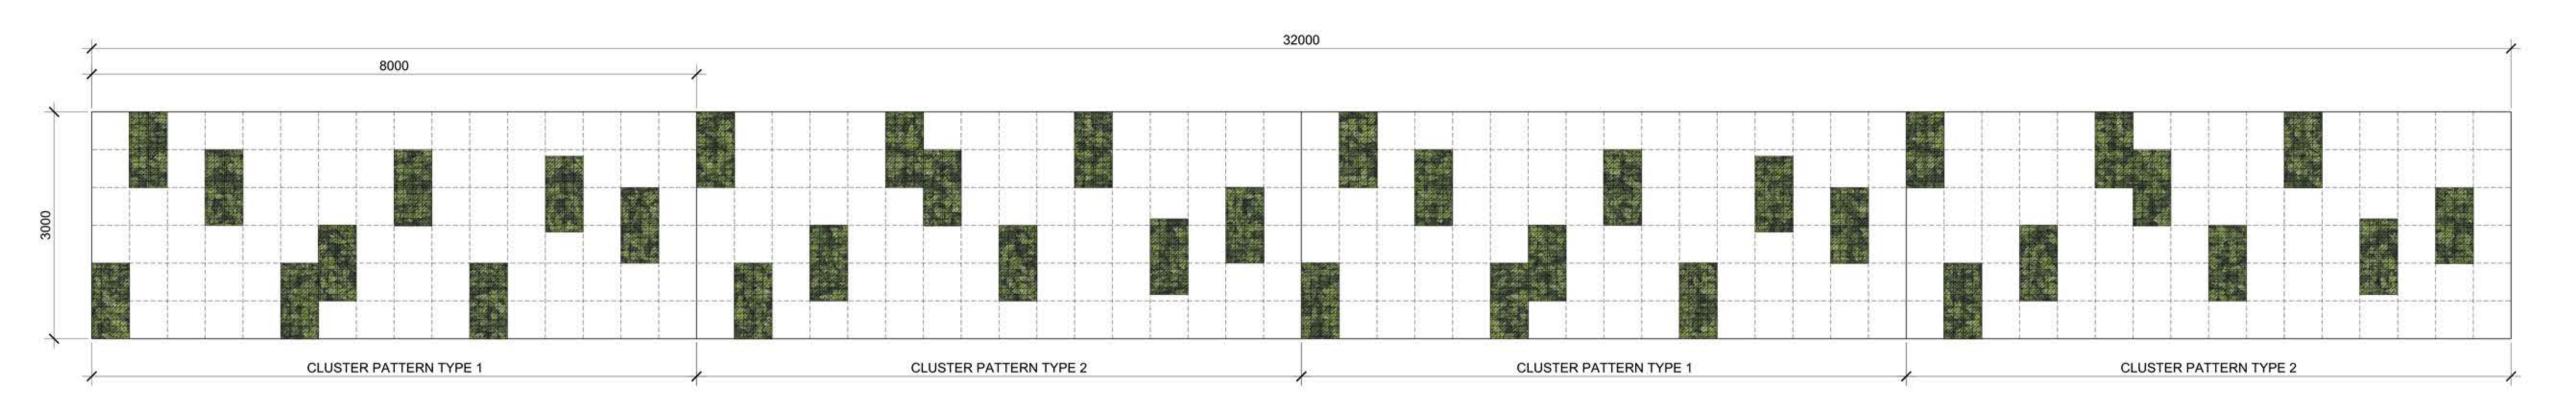


01 ELEVATION - GREEN WALL
1:50


02 L-502 ELEVATION - GREEN WALL

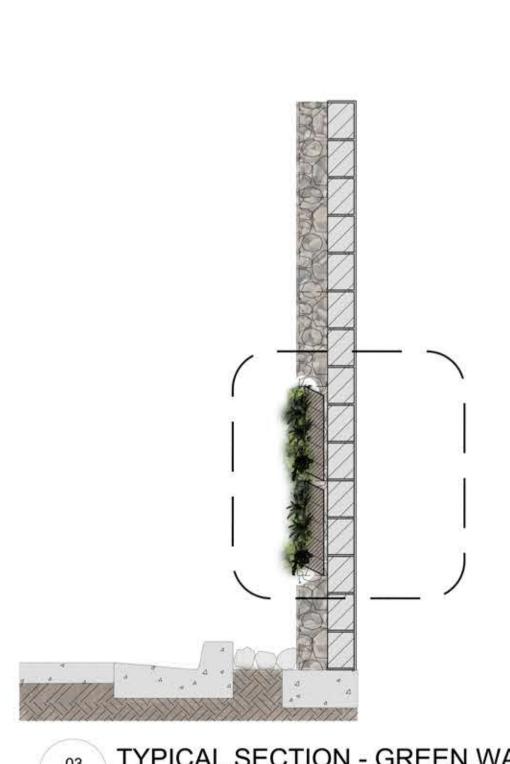



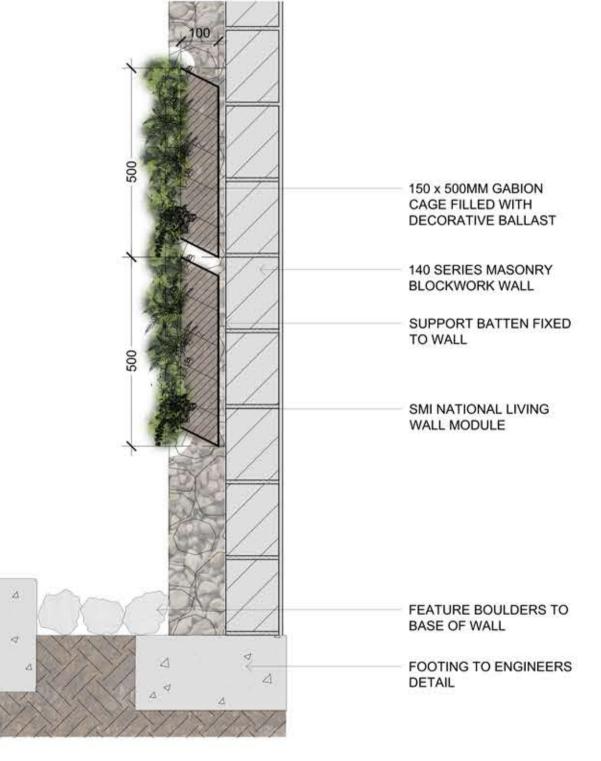

O4 L-502 TYPICAL SECTION - GREEN WALL

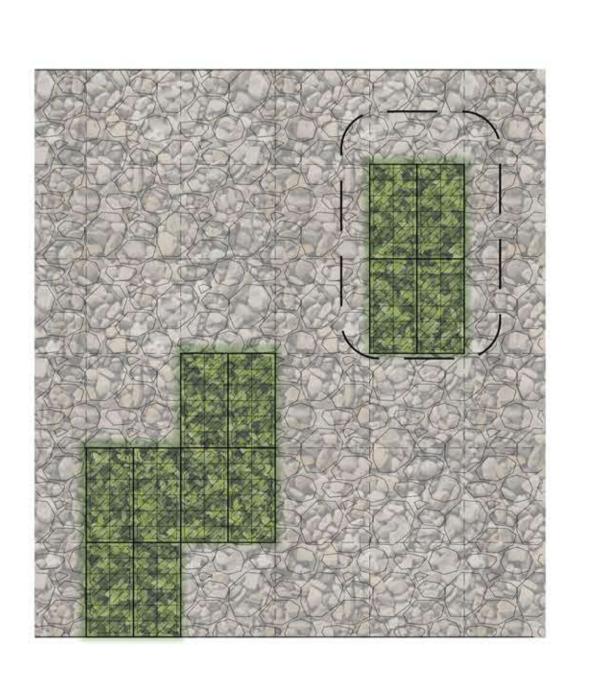

05 DETAILED ELEVATION - GREEN WALL
1:20



06 TYPICAL SECTION - GREEN WALL
1:10

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Issue Revision Description

NP RS 18.03.2020 Drawn Check Date SITE IMAGE

BIN

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Rot

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BINAH Developments

Architect:
Rothelowman Architects

Project:
26 Elizabeth Street

Liverpool NSW 2170

Drawing Name:
Landscape Details
Green Wall

DEVELOPMENT APPLICATION

A1